# CHURCH VIEW SENIOR RESIDENCES

S.R. 981, MOUNT PLEASANT, WESTMORELAND COUNTY, PA JANUARY, 2025

#### **GENERAL NOTES:**

- BEFORE STARTING WORK, THE CONTRACTORS SHALL EXAMINE THE JOB SITE AND THE DRAWINGS AND BE THOROUGHLY FAMILIAR WITH THE ENTIRE CONSTRUCTION, THE FACILITIES, ANY DIFFICULTIES IN THE WORK TO BE COMPLETED, THE ACCURACY OF THE DRAWINGS AND DETAILS. AND QUANTITY OF LABOR AND MATERIALS REQUIRED.
- 2. CONTRACTORS SHALL NOT SCALE THESE DRAWINGS FOR CONSTRUCTION OR BIDDING PURPOSES. IN THE EVENT OF OMISSIONS OF NECESSARY DIMENSIONS OR INFORMATION, THE CONTRACTOR SHALL NOTIFY THE ARCHITECT OR ENGINEER. FIGURED AND CALCULATED DIMENSIONS TAKE PRECEDENCE OVER SCALED MEASUREMENTS. DETAILED DRAWINGS AND LARGER SCALE DRAWINGS TAKE PRECEDENCE
- 3. ALL PLAN DETAILS AND WALL SECTIONS ARE CONSIDERED "TYPICAL" INDUSTRY DETAILS UNLESS NOTED OTHERWISE AS SITE SPECIFIC.
- 4. TRAFFIC SHALL BE MAINTAINED ON ALL ADJOINING STREETS AND DRIVES AT ALL TIMES. TRAFFIC CONTROL SHALL BE MAINTAINED IN ACCORDANCE WITH PENNDOT'S REQUIREMENTS.
- 5. CONTRACTOR SHALL VERIFY THE LOCATION AND INVERT ELEVATION OF ALL EXISTING UTILITIES WITH PROPOSED CONNECTIONS PRIOR TO CONSTRUCTION AND GRADING OF THE SITE. THE ENGINEER SHALL BE IMMEDIATELY NOTIFIED OF ANY DESIGN CONFLICTS.
- 6. ALL MATERIALS AND WORKMANSHIP INVOLVED IN THIS SITE WORK SHALL BE IN ACCORDANCE WITH THE LATEST EDITION. INCLUDING SUPPLEMENTS, OF THE PENNSYLVANIA DEPARTMENT OF TRANSPORTATION SPECIFICATIONS PUB. FORM 408, UNLESS OTHERWISE NOTED.
- 7. A PENNDOT HIGHWAY OCCUPANCY PERMIT, PURSUANT TO SECTION 420 OF THE ACT OF JUNE 1, 1945 (P.L. 1242 NO. 428), KNOWN AS THE "STATE HIGHWAY LAW" IS REQUIRED FOR DRIVEWAY ACCESS TO ANY STATE ROADWAY.
- 8. A FINAL EROSION AND SEDIMENTATION CONTROL PLAN AND PERMIT PURSUANT TO THE RULES AND REGULATIONS OF THE PENNSYLVANIA DEPARTMENT OF ENVIRONMENTAL PROTECTION (TITLE 25, PART 1, SUBPART C, ARTICLE II, CHAPTER 102 OF THE PENNSYLVANIA CODE) IS REQUIRED BEFORE ANY EARTH MOVING ACTIVITIES ON THE PROPOSED LOTS IS ALLOWED.
- 9. ALL PROPOSED ACCESSIBLE FACILITIES ARE TO BE CONSTRUCTED TO CURRENT ADA REQUIREMENTS AND STANDARDS.
- 10. ALL PROPOSED ON-SITE LIGHTING SHALL BE DIRECTED INWARD AND DOWNWARD AWAY FROM RESIDENTIAL PROPERTIES AND ALL STREET RIGHT-OF-WAYS.

11. LAND DEVELOPMENT PLAN APPROVAL DOES NOT RELIEVE THE OWNER FROM ALL APPLICABLE SIGN REGULATIONS. ALL PROPOSED ON-SITE

CONSTRUCTION CONTRACT IS ISSUED, THE CONTRACTOR ACKNOWLEDGES THE CONTRACT PRICE COVERS ALL LABOR, MATERIALS AND

- SIGNAGE SHALL CONFORM TO THE MUNICIPAL ZONING ORDINANCES. 12. CONTRACTOR IS RESPONSIBLE FOR VERIFYING QUANTITIES, INCLUDING EARTHWORK. IT IS THE RESPONSIBILITY OF THE CONTRACTOR TO NOTIFY THE OWNER AND ENGINEER DURING THE BIDDING PROCESS OF ANY QUANTITY DISCREPANCIES IN THE BID DOCUMENTS. ONCE THE
- INCIDENTALS TO SUBSTANTIALLY COMPLETE THE PROJECT ACCORDING TO THE CONSTRUCTION PLANS. 13. IT IS THE INTENTION OF THE ENGINEER THAT THE DRAWINGS AND SPECIFICATIONS PROVIDE FOR A COMPLETELY FINISHED PROJECT. ANYTHING OR MATTER SHOWN ON THE DRAWINGS OR DESCRIBED BY THE SPECIFICATIONS OR FAIRLY IMPLIED BY EITHER OR BOTH, SHALL BE CONSIDERED A PART OF THE WORK THE SAME AS IF NOTED, SHOWN AND DESCRIBED. SHOULD THE CONTRACTORS FIND ANY DISCREPANCIES OR OMISSIONS IN THE DRAWINGS OR SPECIFICATIONS, OR BE IN DOUBT AS TO THEIR MEANING, THEY SHALL NOTIFY THE ENGINEER PRIOR TO PROCEEDING WITH THE WORK. ANY CLARIFICATIONS FROM THE ENGINEER WILL BE WRITTEN AND THE CONTRACTORS SHALL BE RESPONSIBLE AT NO COST TO THE OWNER OR ENGINEER FOR ANY WORK WHICH MUST BE REDONE BECAUSE OF THEIR
- 14. FURTHER EXPLANATORY DRAWINGS OR DETAILS WILL ALSO BE CONSIDERED PART OF THE PROJECT AND WORK EXECUTED WITHOUT SUCH DETAILS SHALL BE AT THE CONTRACTOR'S RISK.
- 15. THE CONTRACTOR SHALL VERIFY AND BE RESPONSIBLE FOR ALL DIMENSIONS AND MEASUREMENTS. ANY DISCREPANCIES BETWEEN THE DRAWING AND ACTUAL EXISTING CONDITIONS SHALL BE REPORTED TO THE ENGINEER BEFORE PROCEEDING. ANY CHANGES OR CORRECTIONS WILL BE WRITTEN, AND THE CONTRACTORS SHALL BE RESPONSIBLE FOR ANY WORK COMPLETED BEFORE RECEIVING SAID
- 16. IN THE CASE OF AN INCONSISTENCY BETWEEN DRAWINGS AND SPECIFICATIONS, OR WITHIN EITHER DOCUMENT NOT CLARIFIED BY AN ADDENDUM, THE BETTER QUALITY OR GREATER QUANTITY OF WORK SHALL BE PROVIDED IN ACCORDANCE WITH THE ENGINEER AND THE OWNER'S REPRESENTATIVES INTERPRETATION.

<u>GAS</u>

# UTILITY COMPANIES

**SANITARY** MOUNT PLEASANT TOWNSHIP PO BOX 137

FAILURE TO COMPLY WITH THE PRECEDING.

PEOPLES NATURAL GAS 195 Donohoe Road Greensburg, PA 15601 MAMMOTH PA 15664 Colleen Corona 724-424-5418 (724) 832-2856

MUNICIPAL AUTHORITY OF WESTMORELAND COUNTY 124 Park and Pool Road New Stanton, PA 15672 (724) 755-5800

TELEPHONE/FIBER OPTICS

WINDSTREAM COMMUNICATIONS 186 MAIN STREET BROOKVILLE, PA. 15825

### **ELECTRICITY**

FIRST ENERGY-WEST PENN POWER 800 CABIN HILL ROAD GREENSBURG, PA. 15601 Office Personnel


## <u>CABLE</u>

COMCAST 201 NORTH TREMONT AVENUE GREENSBURG, PA. 15601



CALL BEFORE YOU DIG IN PENNSYLVANIA 1-800-242-1776 DESIGN SN: 20241833199

THE GENERAL CONTRACTOR SHALL NOTIFY ALL UTILITY COMPANIES INVOLVED IN THE SITE NO MORE TEN DAYS AND NO LESS THAN THREE DAYS IN ADVANCE OF EXCAVATION (PA ACT 287 OF 1974 AMENDED BY ACT 50 OF 2018). PA STATE LAW REQUIRES 3 WORKING DAYS NOTICE

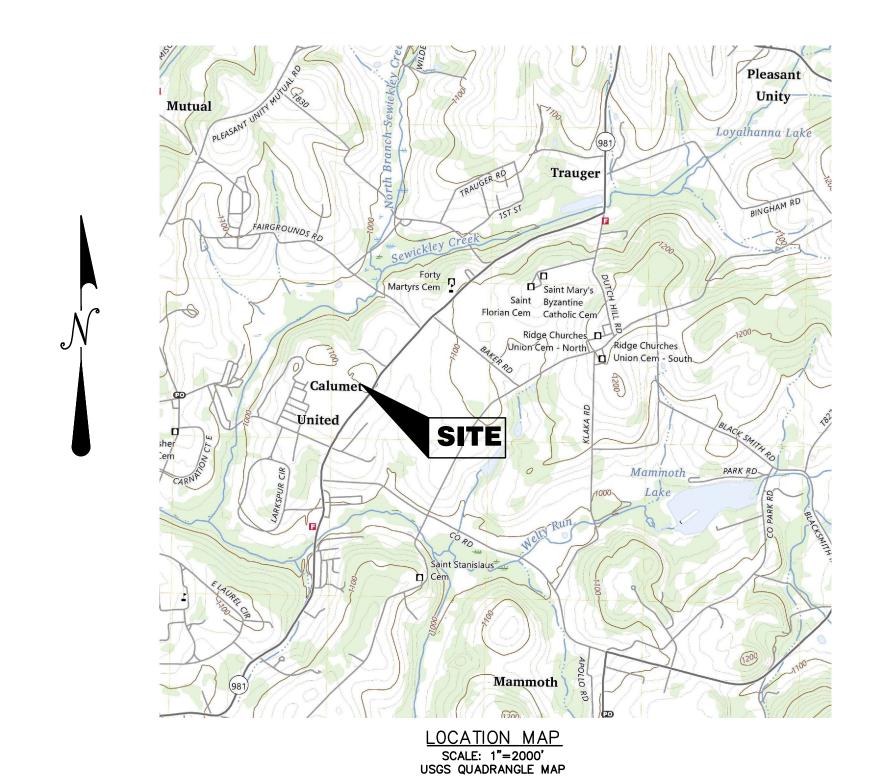

# PREPARED FOR:

# **WESTMORELAND COUNTY HOUSING AUTHORITY**

167 S. GREENGATE RD. GREENSBURG, PA 15601 ATTN - ERIK SPIEGEL PHONE - 724-832-7248

PREPARED BY:



Morris Knowles & Associates, Inc.

Consulting Engineers & Land Surveyors 1740 GOLDEN MILE HIGHWAY, SUITE 101 MONROEVILLE, PA. 15146

TELEPHONE: (724) 468-4622 FAX: (724) 468-8940


#### INDEX OF SHEETS

TITLE SHEET	C000
EXISTING CONDITIONS/DEMOLITION PLAN	C100
SITE PLAN	C200
GRADING PLAN	C300
DRAINAGE PLAN & PROFILE	C300
UTILITY PLAN	C400
GENERAL DETAILS	C600-C603
EROSION AND SEDIMENT CONTROL PLAN	C700
EROSION AND SEDIMENT CONTROL TITLE SHEET	C700
EROSION AND SEDIMENT CONTROL PLAN	C701
EROSION AND SEDIMENT CONTROL DETAIL SHEETS	C701-C702
POST CONSTRUCTION STORMWATER MANAGEMENT PLAN	C800
POST CONSTRUCTION STORMWATER MANAGEMENT DETAILS	C801-C802

THE ENGINEER ASSUMES NO RESPONSIBILITY FOR ANY CHANGES IN DESIGN PLANS UNLESS WRITTEN CONSENT IS GIVEN BY THE ENGINEER. THE CONTRACTOR AND/OR THE OWNER WILL BE HELD RESPONSIBLE FOR ANY FIELD MODIFICATIONS MADE WITHOUT THE WRITTEN CONSENT OF THE ENGINEER AND NECESSARY APPROVALS BY PERMITTING AGENCIES.


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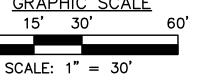
SHEET NO. C000

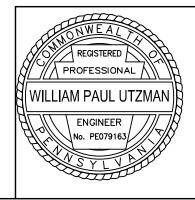


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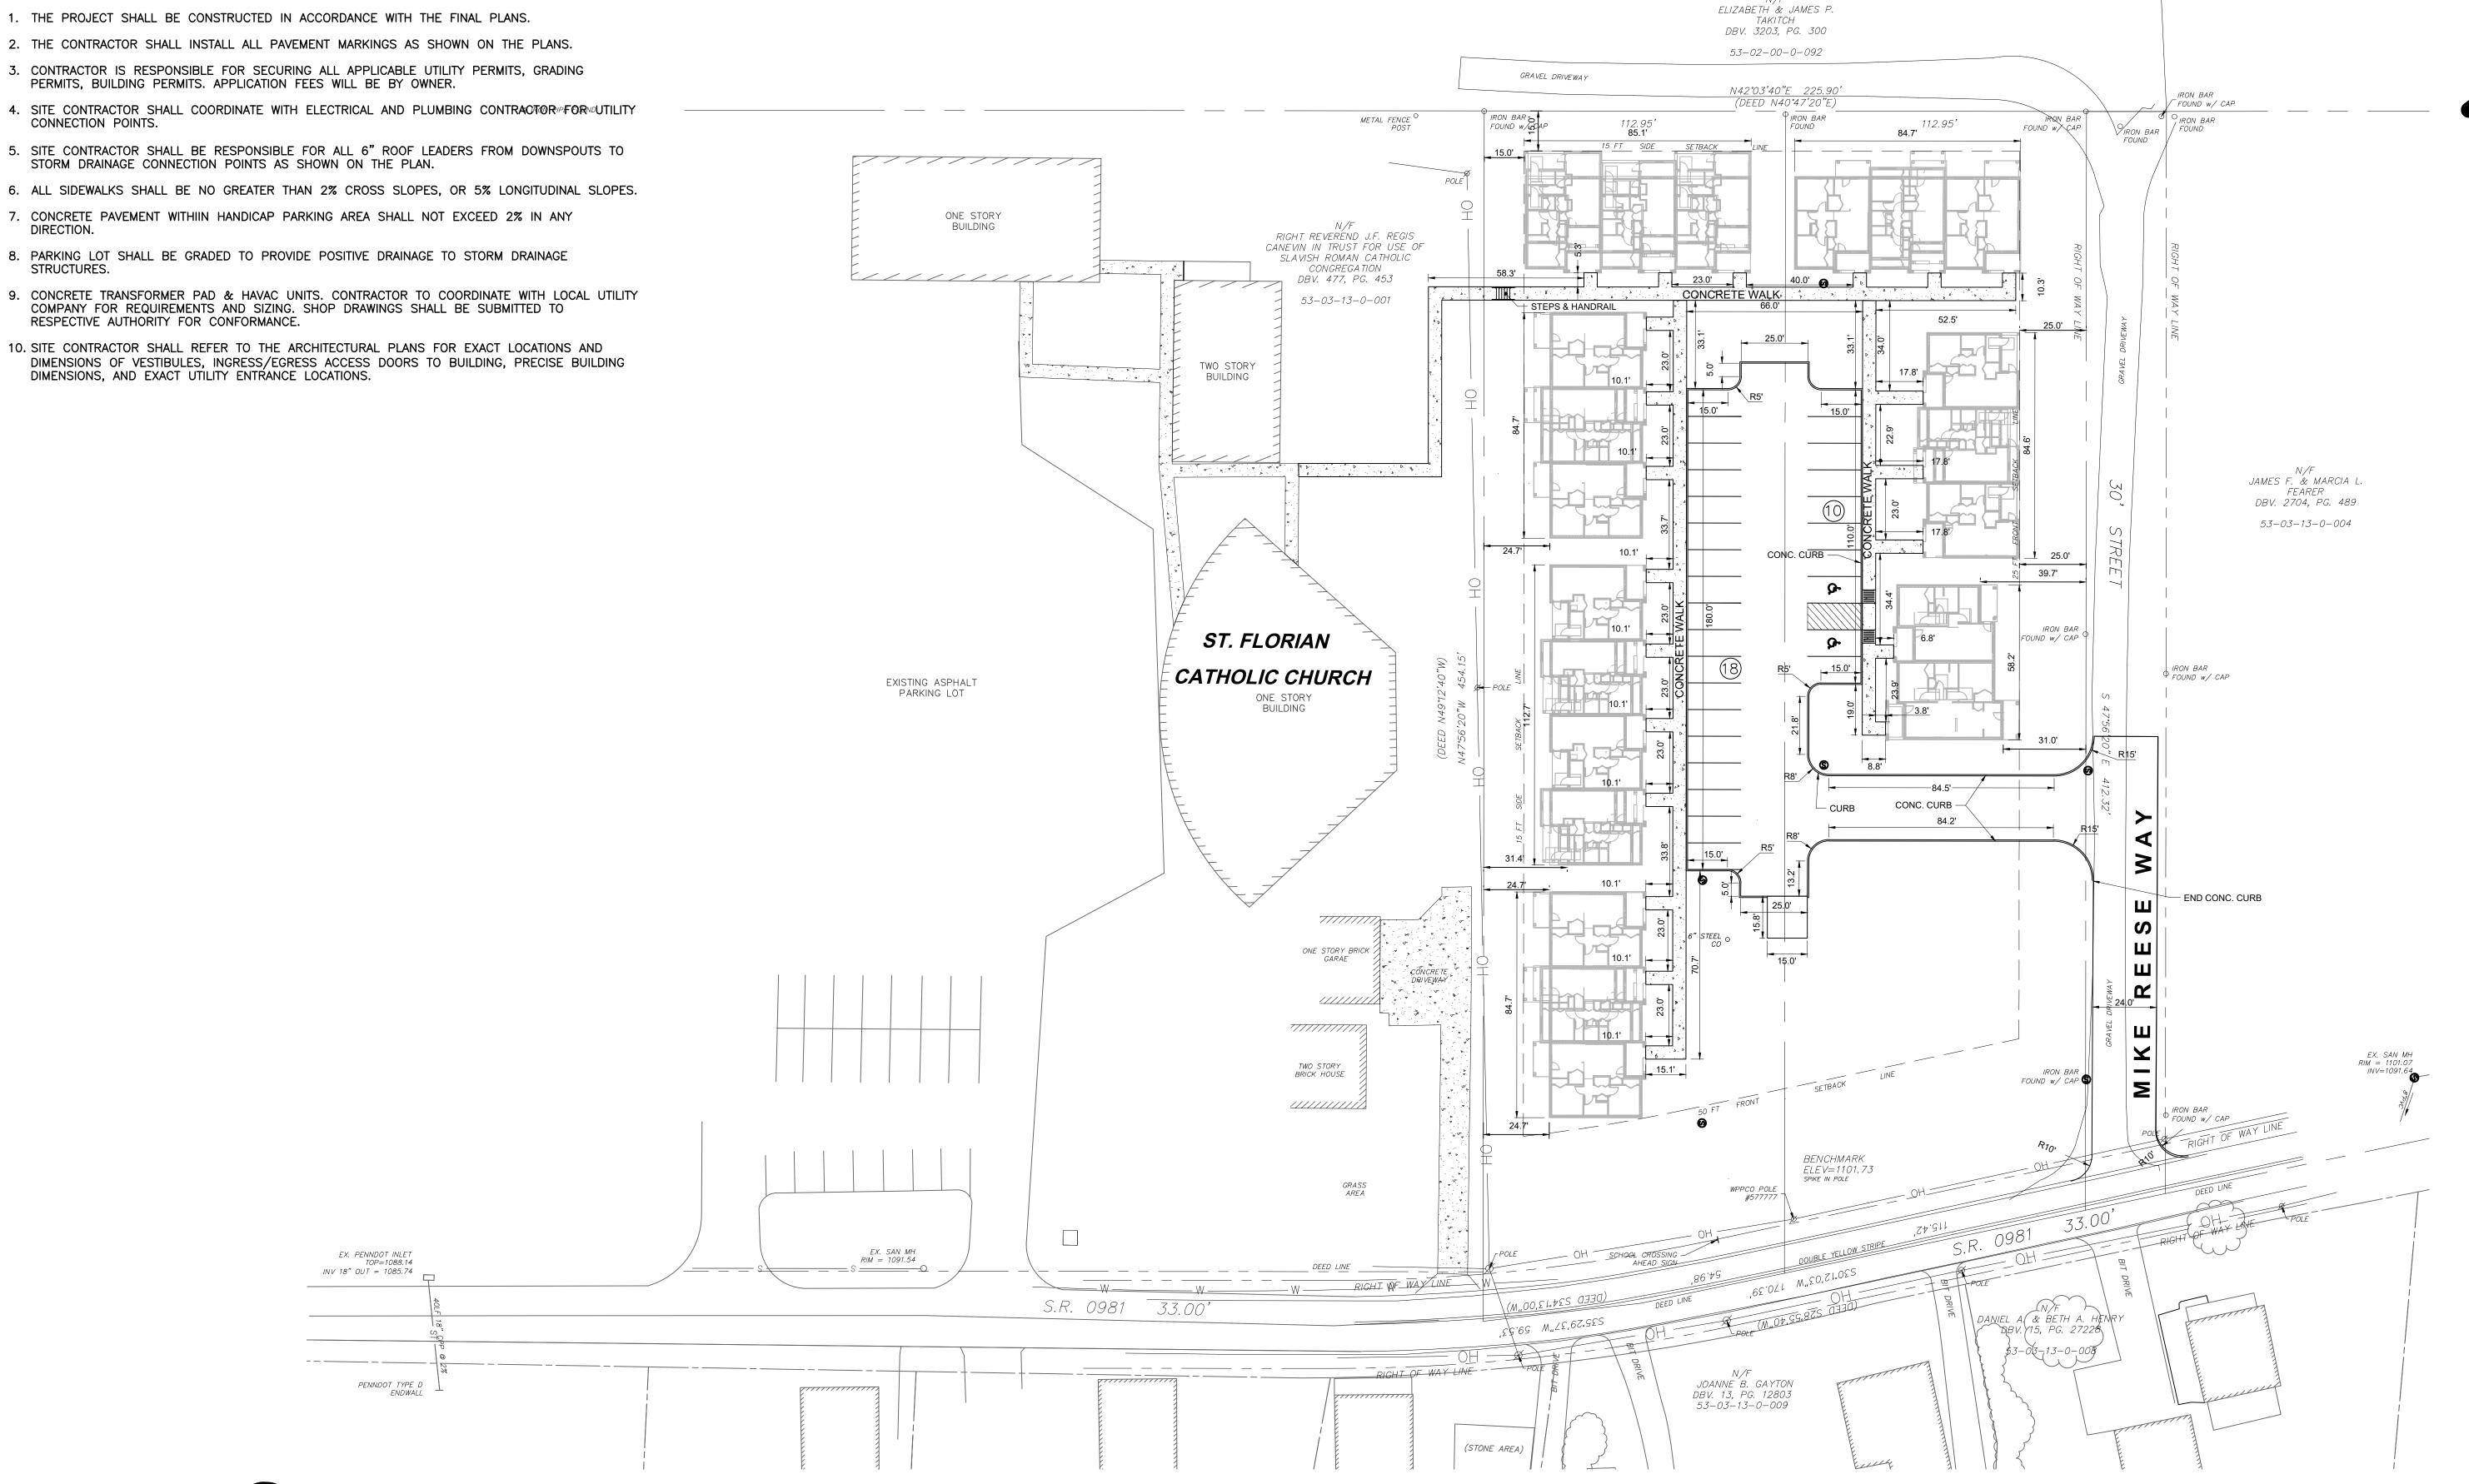
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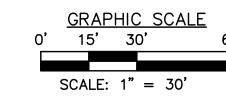
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### <u>SITE PLAN NOTES:</u>



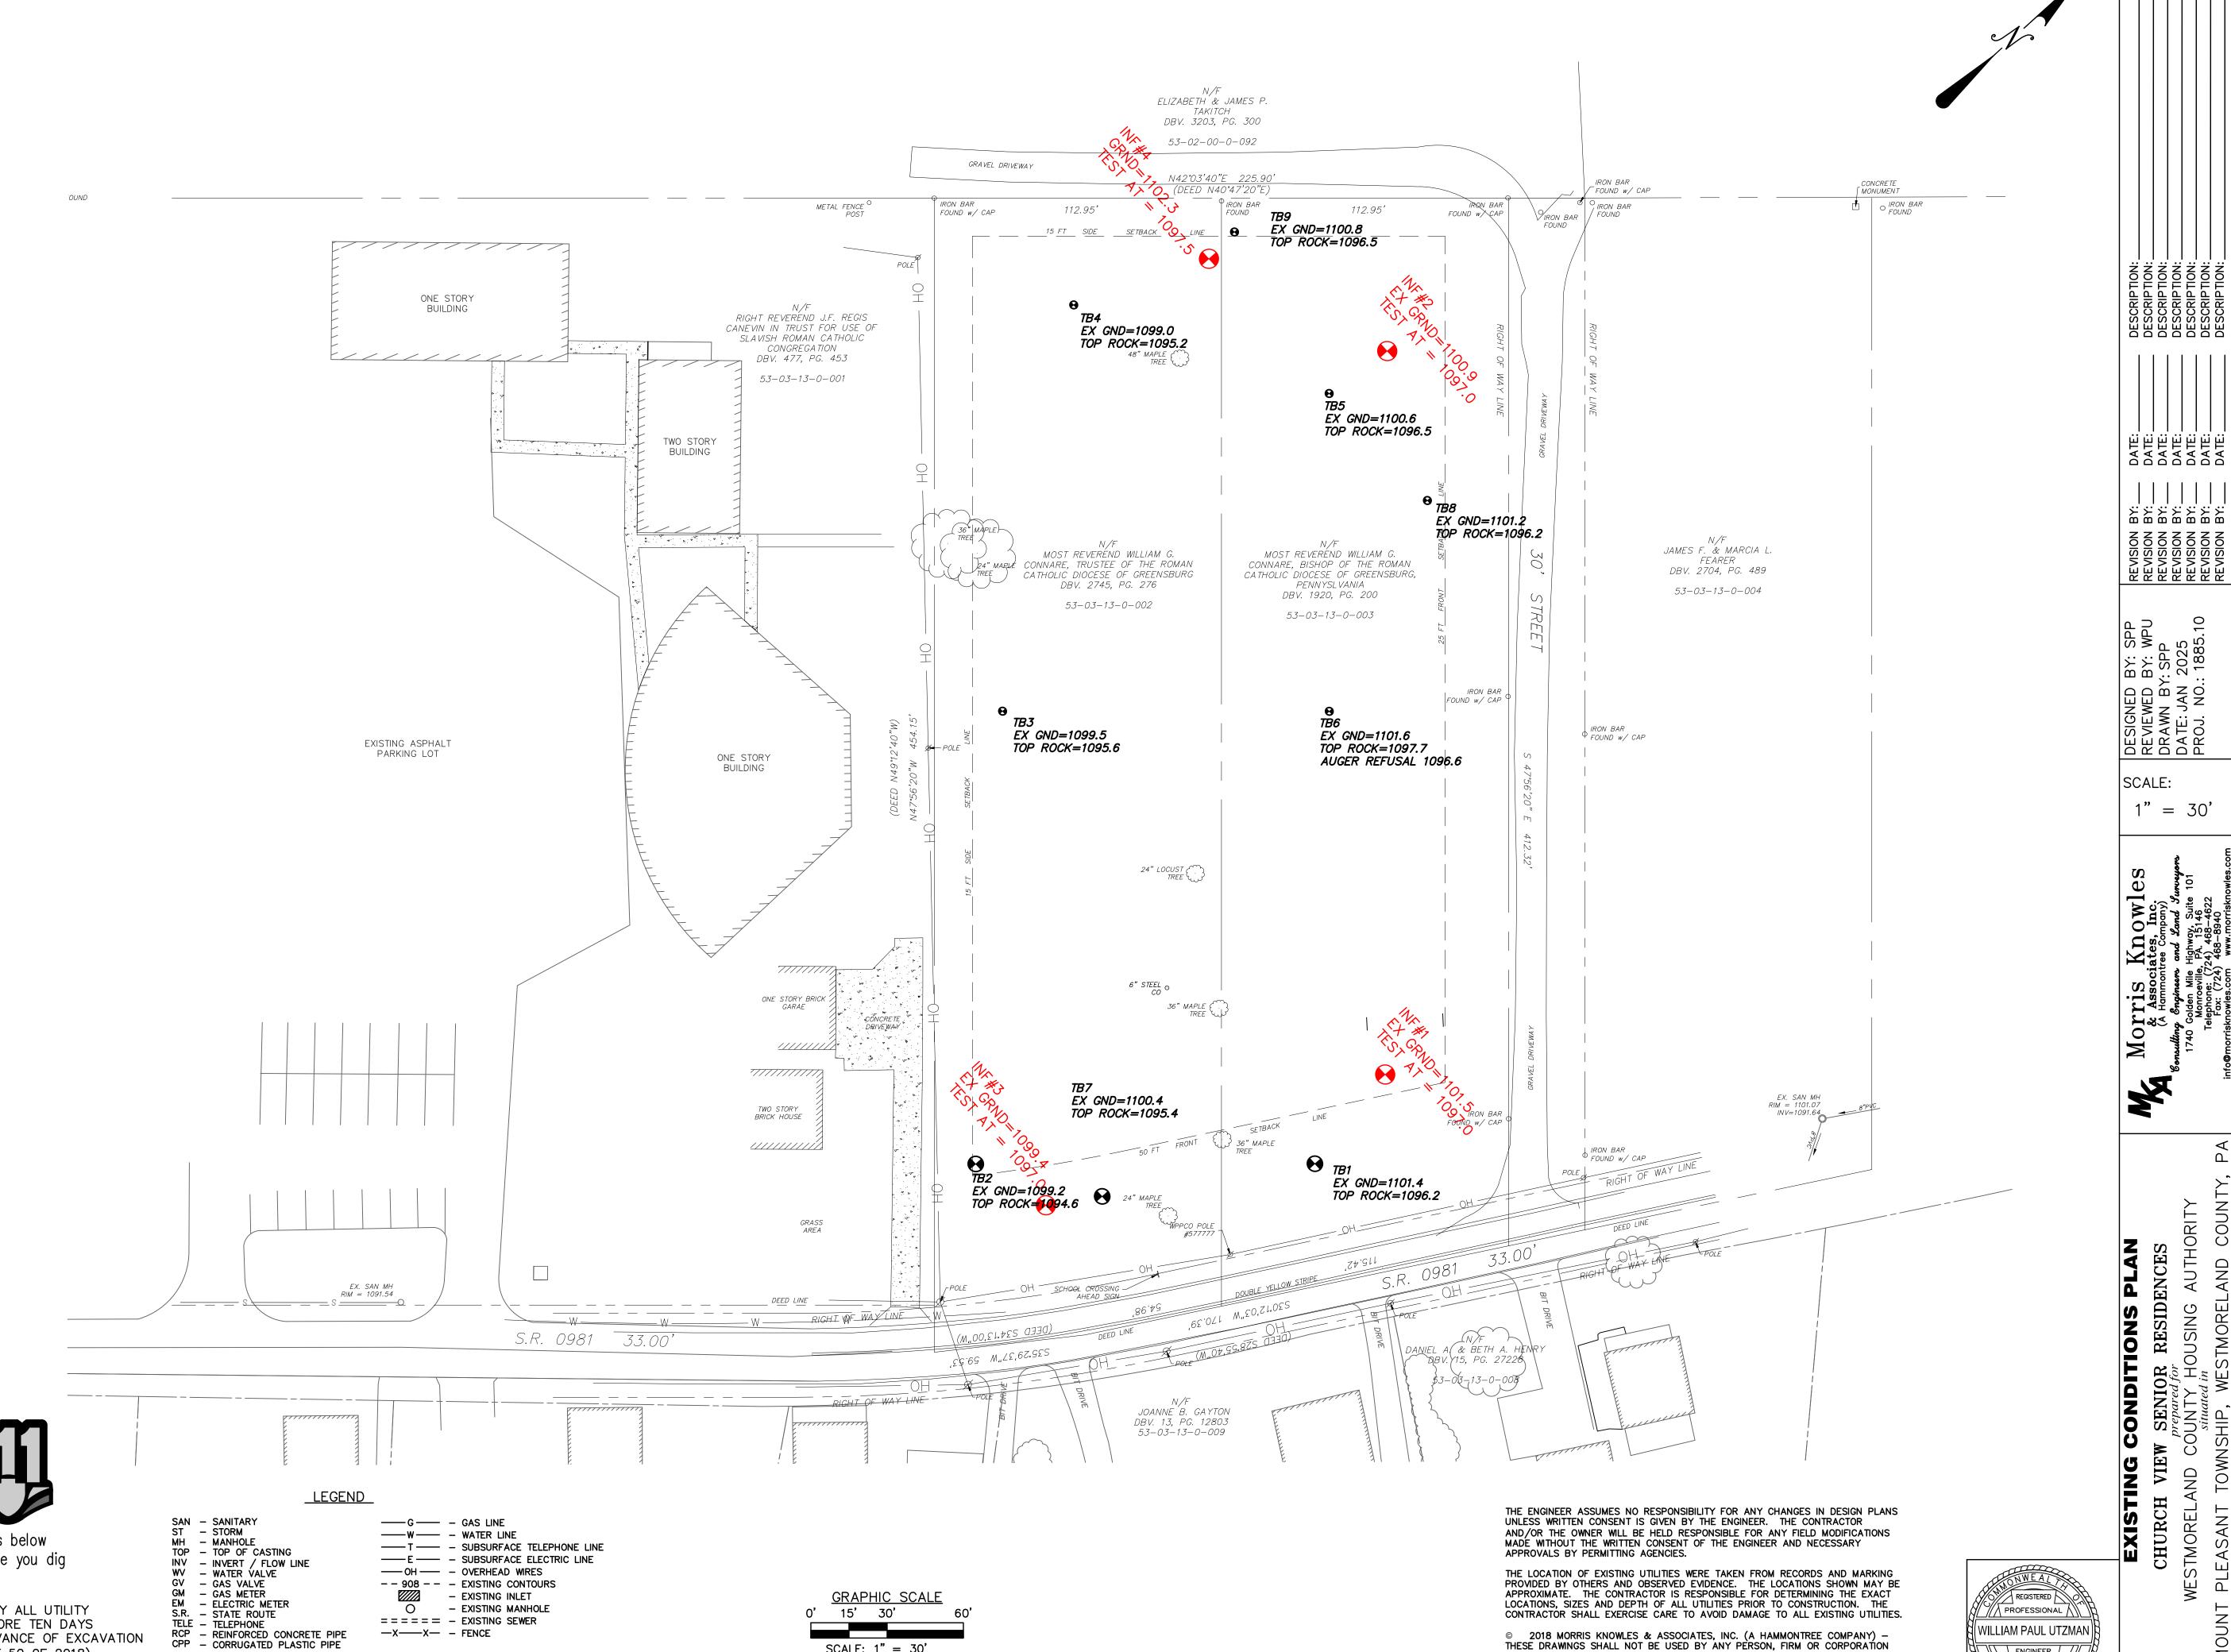

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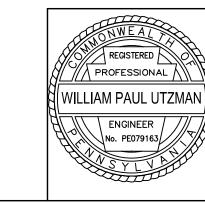


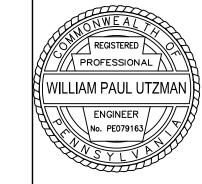

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SHEET NO. C200


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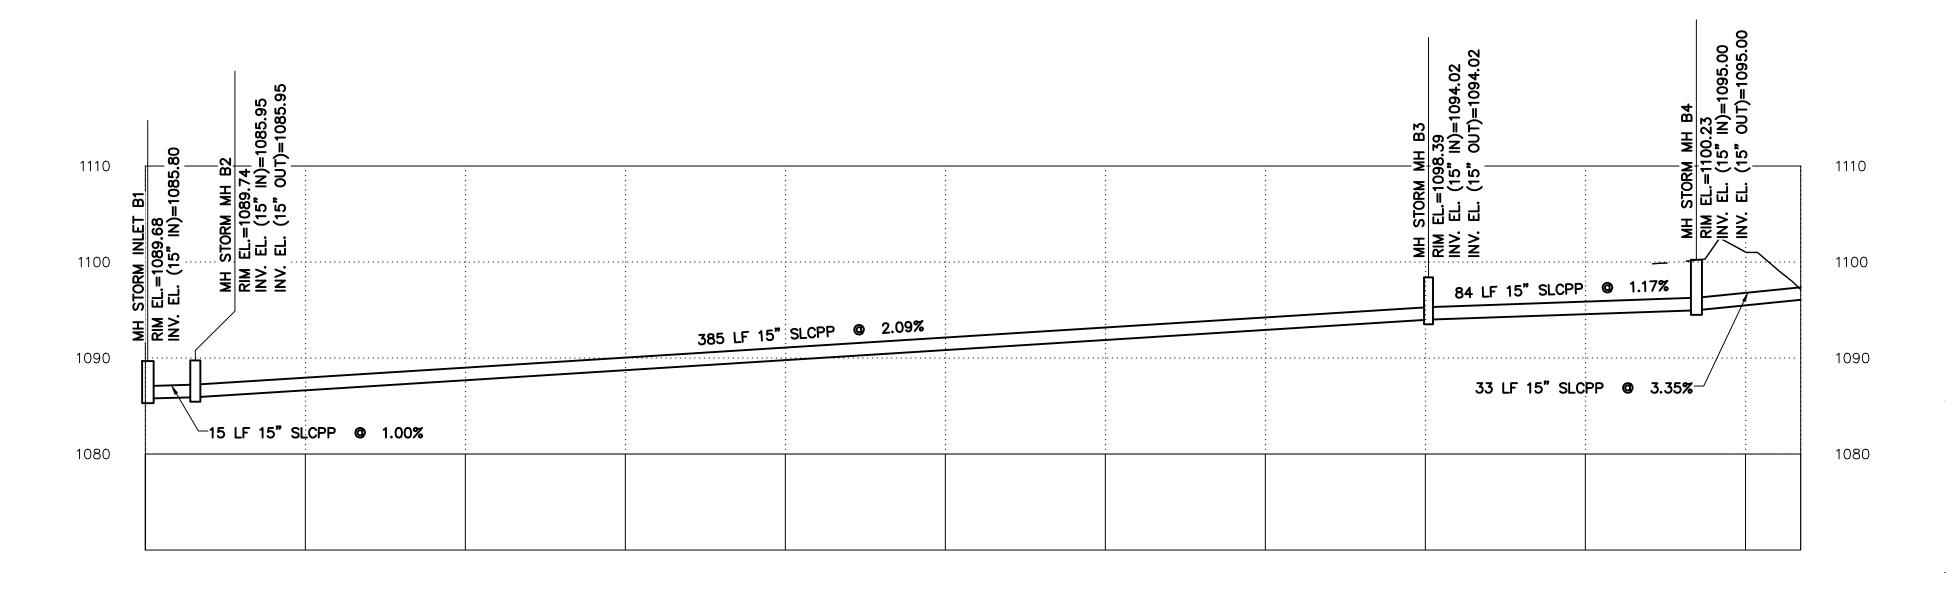
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1" = 30'

SCALE:

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Storm Drainage Profile 1 PROFILE - STA. 0+00 TO STA. 5+17 HORIZ SCALE: 1"=30'

SCALE: 1" = 30'

Storm Pipe Table					
Pipe Name	Size	Length	Slope		
P1	15"	15FT	1.00%		
P2	15"	385FT	2.09%		
Р3	15"	86FT	1.14%		
P4	15"	33FT	3.33%		
P5	12"	13FT	0.05%		
P6	15"	41FT	0.75%		
P7	12"	40FT	6.55%		
P8	12"	13FT	0.60%		
P9	12"	11FT	0.50%		
P10	12"	64FT	0.50%		
P11	12"	91FT	0.50%		

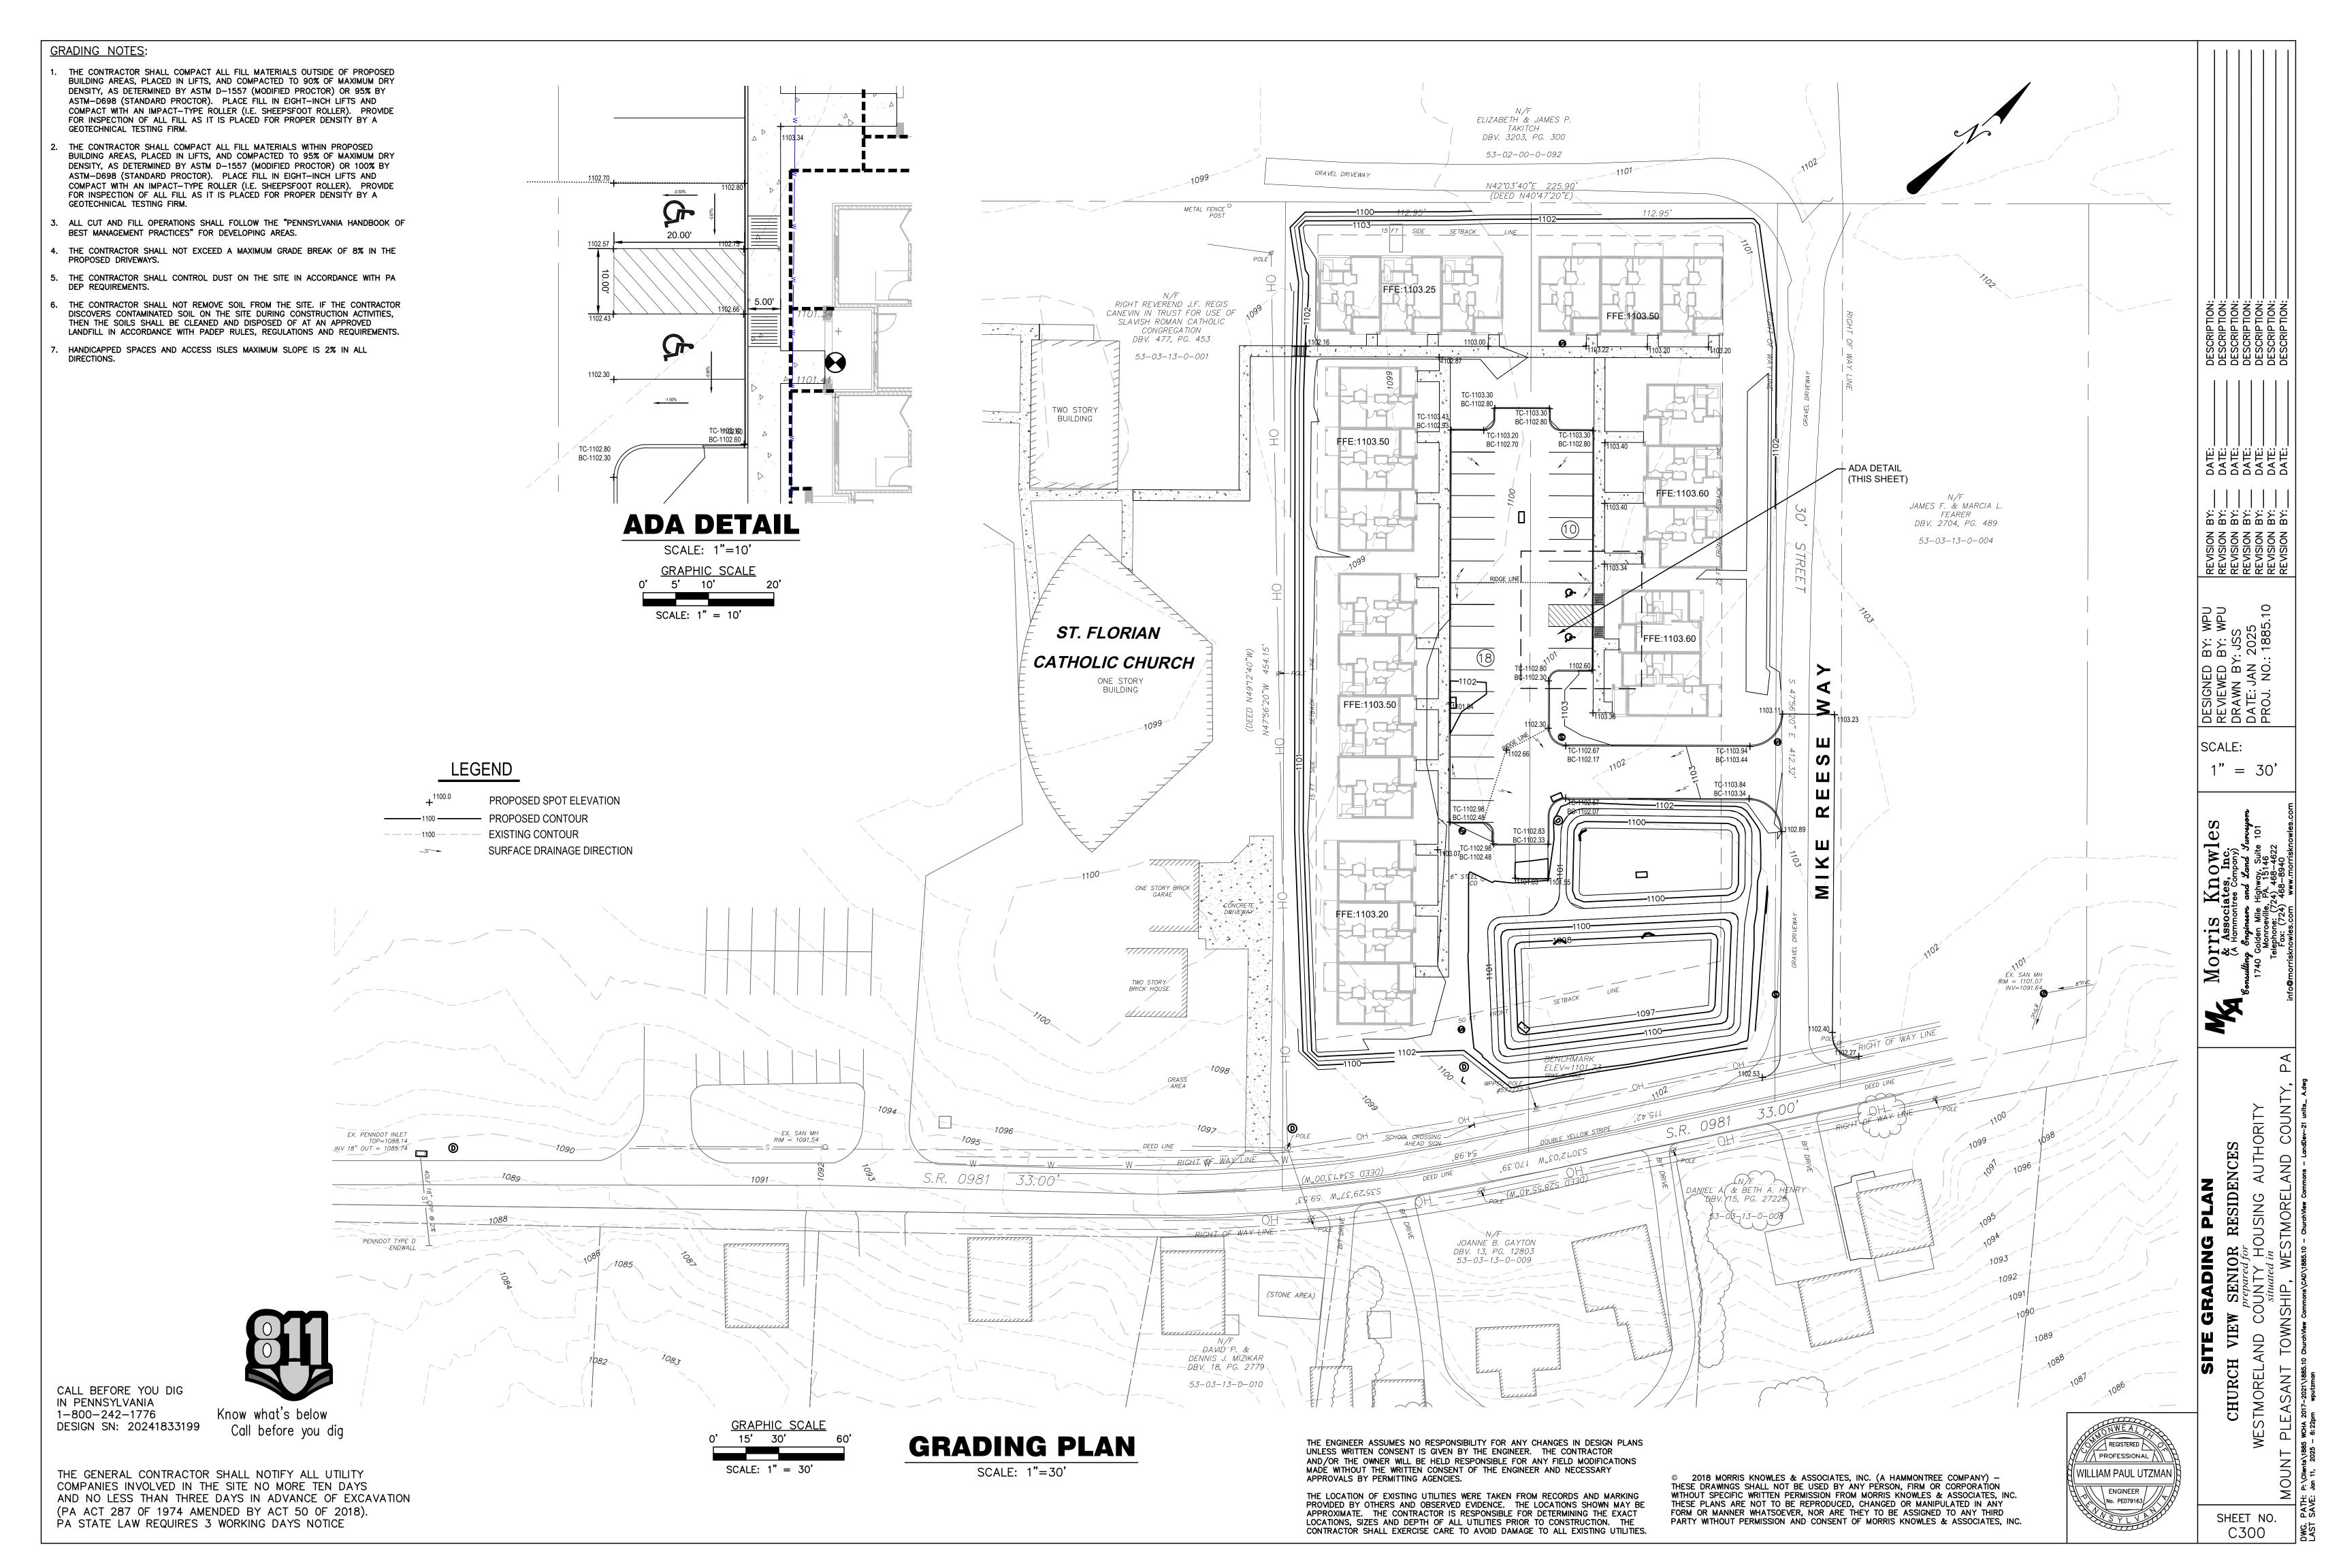Storm Structure Table						
STRUCTURE	TYPE	RIM	INVERT IN	INVERT OUT	INVERT OUT	
B1	INLET	1089.7	1085.80	1085.74		
B2	MANHOLE	1089.7	1085.95	1085.95		
В3	MANHOLE	1098.4	1094.02	1094.02		
B4	MANHOLE	1100.2	1095.00	1095.00		
B5	INLET	1100.8		1096.10		
В6	ENDWALL			1097.00		
В7	MANHOLE	1101.8	1097.17	1097.07		
B8	MANHOLE	1102.0	1097.50	1097.48		
В9	ENDWALL			1199.00		
B10	MANHOLE	1103.0	1099.08	1199.08	1100.10	
B11	INLET	1102.1	1099.13	1099.13		
B12	INLET	1101.9	1099.45	1099.45		
B13	INLET	1102.1	1099.90			


\* STORM MH B10 (STORMWATER FLOW SPLITTER, REFER TO C802)




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## LEGEND

PROPOSED STORM SEWER

— — — 6" PVC ROOF LEADERS (MIN SLOPE @ 1/8" PER FT)

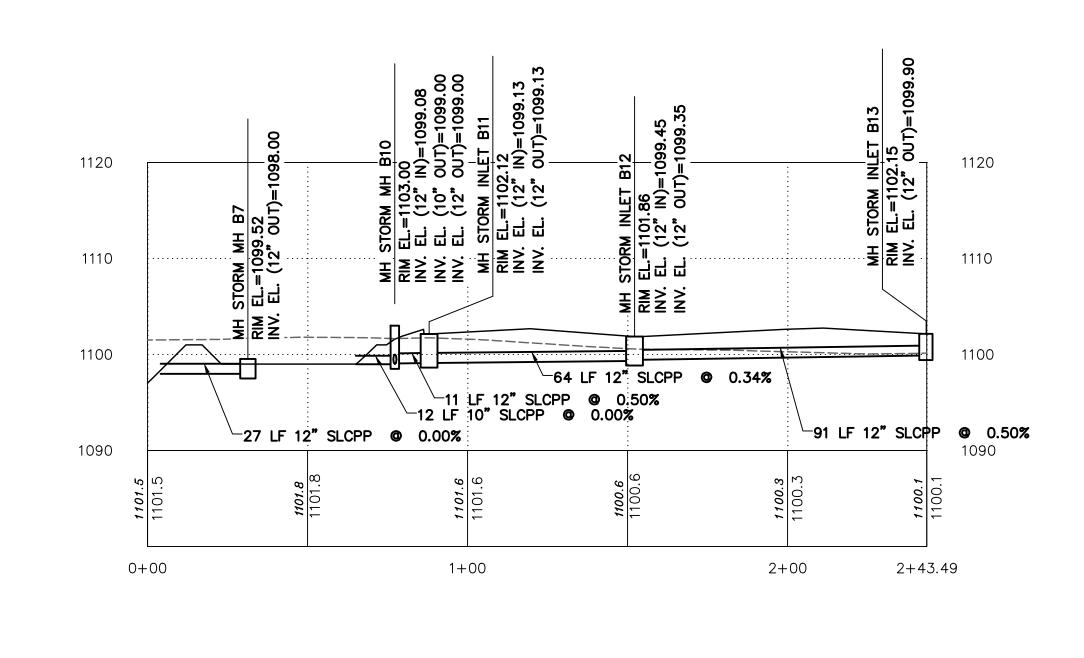— — — EXISTING CONTOUR

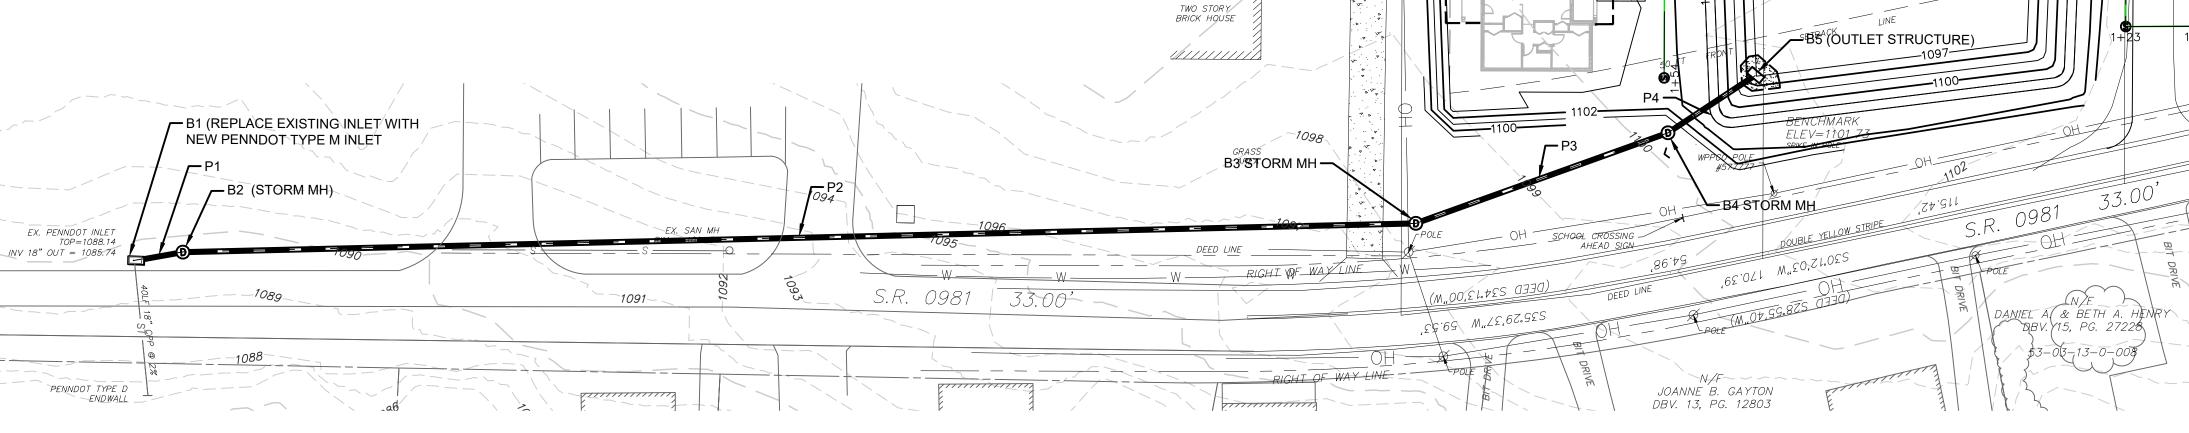SURFACE DRAINAGE DIRECTION

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B6 (TYPE D-W ENDWALL)

DBV. 3203, PG. 300

53-02-00-0-092

N42°03'40"E 225.90 (DEED N40°47'20"E)

GRAVEL DRIVEWAY

METAL FENCE C POST

N/F
RIGHT REVEREND J.F. REGIS
CANEVIN IN TRUST FOR USE OF
SLAVISH ROMAN CATHOLIC
CONGREGATION
DBV. 477, PG. 453


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TORY )ING

> ONE STORY BUILDING

> > ONE STORY BRICK GARAE

> > > CONCRETE DRIVEWAY

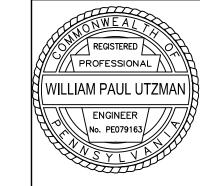

B7 (OUTLET

STRUCTURE)

DRAINAGE PLAN & PROFILE
CHURCH VIEW SENIOR RESIDENCES

DATE: DATE: DATE: DATE: DATE: DATE:

REVISION REVISION REVISION REVISION REVISION REVISION REVISION

DESIGNED BY: V REVIEWED BY: V DRAWN BY: JSS DATE: JAN 2025 PROJ. NO.: 188

1" = 30'

SCALE:

Morris Knowles & Associates, Inc. (A Hammontree Company)

UTZMAN SHEET

SHEET NO. C301

CHURCH VI

#### **WATERLINE NOTES:**

1. WATERLINE SHALL CONFORM TO AWWA C900 FOR PVC PLASTIC PIPE. PVC WATERLINE PIPE SHALL BE CLASS 200, DR-14 PVC PIPE. FITTINGS SHALL CONFORM TO AWWA C110.

**CONTRACTOR NOTES:** 

WORK EXCEPT THE FOLLOWING.

STATION, ALL WIRING.

INSTALLED BY E.C.

MIN. 4.0' DEPTH

1. GENERAL CONTRACTOR IS RESPONSIBLE FOR ALL SITE

1.1. ELECTRICAL CONTRACTOR SHALL FURNISH ALL SITE

CONDUIT TO BE INSTALLED BY G.C. SEE GENERAL

ELECTRICAL NOTES NO. 6 FOR MORE INFORMATION.

1.2. ELECTRICAL CONTRACTOR SHALL FURNISH POLE LIGHT

ANCHOR BOLTS AND BOLT PATTERN TEMPLATE. GENERAL CONTRACTOR TO PROVIDE POLE LIGHT

1.3. ELECTRICAL CONTRACTOR TO PROVIDE, FURNISH AND

INSTALL LIGHT FIXTURES, LIGHT POLES, CAR CHARGING

└-4" SPARE CONDUIT

LEGEND

FOUNDATIONS AND INSTALL BOLTS.

E.C. SHALL FURNISH SITE CONDUIT FOR INSTALLATION

BY G.C. FOR ALL SITE ELECTRICAL WORK EXCEPT FOR

1. ALL SITE WIRING SHALL BE FURNISHED AND

2. EC SHALL PROVIDE SITE LIGHT FIXTURES AND

3. EC SHALL FURNISH BOLT PATTERNS FOR SITE

4. GC SHALL INSTALL ALL PADS AND FOUNDATIONS

5. EC SHALL FURNISH AND INSTALL CONDUIT AND

4" CABLE CONDUIT-

4" TELEPHONE CONDUIT

TYPICAL CONDUIT TRENCHING

SAN - SANITARY ST - STORM

MH - MANHOLE

TOP - TOP OF CASTING

WV – WATER VALVE

GAS VALVE

S.R. – STATE ROUTE

GAS METER

TELEPHONE

INV - INVERT / FLOW LINE

- ELECTRIC METER

RCP - REINFORCED CONCRETE PIPE

- CORRUGATED PLASTIC PIPE

LIGHT POLES. G.C. SHALL INSTALL LIGHT POLES

POLES. REFER TO SITE DRAWINGS

AND LIGHT POLE FOUNDATIONS.

WIRING FOR CONDENSER UNITS.

EXCEPT CONDENSER PADS.

- 2. WATERLINES CROSSING SEWERS SHALL BE LAID TO PROVIDE A MINIMUM VERTICAL DISTANCE OF 18 INCHES BETWEEN THE OUTSIDE OF THE WATERLINE AND THE OUTSIDE OF THE SEWER. THIS SHALL BE THE CASE WHERE THE WATERLINE IS EITHER ABOVE OR BELOW THE SEWER. AT CROSSINGS, ONE FULL LENGTH OF WATER PIPE SHALL BE LOCATED SO BOTH JOINTS WILL BE AS FAR FROM THE SEWER AS POSSIBLE, SPECIAL STRUCTURAL SUPPORT FOR THE WATER AND SEWER PIPES MAY
- 3. ALL TYPES OF INSTALLED WATER PIPE SHALL BE PRESSURE TESTED AND LEAKAGE TESTED IN ACCORDANCE WITH THE LASTEST EDITION OF AWWA STANDARD C600.
- 4. ALL NEW, CLEANED OR REPAIRED WATERLINES SHALL BE DISINFECTED IN ACCORDANCE WITH AWWA
- 5. ALL WATERLINE PIPES, FITTINGS AND ACCESSORIES SHALL CONFORM TO THE REQUIREMENTS OF THE FOLLOWING STANDARD SPECIFICATIONS: A.21.10 ANSI, A.21.11 ANSI, A.21.50 ANSI, A.21.51
- 6. SHOP DRAWINGS AND CATALOG CUTS FOR ALL MATERIALS USED IN CONSTRUCTION MUST BE APPROVED BY THE AUTHORITY PRIOR TO THE START OF WORK.
- 7. ALL MATERIALS FOR THE PROPOSED WATERLINE SHALL BE PURCHASED FROM THE MUNICIPAL AUTHORITY OF XXXXXX COUNTY.
- 8. THE PROPOSED WATERLINE SHALL BE IN ACCORDANCE WITH THE MUNICIPAL AUTHORITY OF XXXXXXXX COUNTY SPECIFICATIONS. THE AUTHORITY WILL INSPECT THE INSTALLATION OF WATERLINES AND CONNECTIONS.

#### **UTILITY NOTES:**

- 1. ALL EXISTING UTILITIES SERVING THIS PROPERTY SHALL BE PROPERLY TERMINATED AT THE RIGHT-OF-WAY LINE IN COMPLIANCE WITH TOWNSHIP AND COUNTY REGULATIONS. CONTRACTOR SHALL PROVIDE EVIDENCE OF COMPLIANCE WITH ALL STATE AND FEDERAL LAWS REGARDING THE DEMOLITION OF STRUCTURES AND ABANDONMENT OF UTILITIES.
- 2. ANY UTILITIES FOUND DURING EXCAVATION, NOT SHOWN ON PLAN, SHALL BE BROUGHT TO THE IMMEDIATE ATTENTION OF THE ENGINEER.
- 3. EACH SUBCONTRACTOR SHALL OBTAIN HIS OR HER OWN PERMITS AND CONTACT THE UTILITY COMPANY FOR VERIFICATION AND LOCATION OF HOOK-UP PRIOR TO ANY WORK BEING DONE.
- 4. UTILITIES SHOWN WERE TAKEN IN PART FROM RECORDS OF RESPECTIVE UTILITY COMPANIES AND PART FROM A SURVEY AND DO NOT NECESSARILY REPRESENT ALL UNDERGROUND OR OVERHEAD UTILITIES ADJACENT TO OR UPON THE PREMISES SHOWN ON THE PLAN.
- 5. THE CONTRACTOR SHALL COORDINATE UTILITY CONNECTIONS AND SIZE AT THE BUILDING WITH THE MECHANICAL DRAWINGS AND PROVIDE CONNECTIONS WITH EXISTING UTILITIES IN ACCORDANCE WITH THE UTILITY PROVIDER'S REQUIREMENTS.
- 6. ALL UTILITIES SHALL BE UNDERGROUND.
- 7. ALL UTILITIES SHALL BE CONSTRUCTED, INSPECTED AND TESTED IN ACCORDANCE WITH THE BOROUGH, CITY, AUTHORITY, OR COUNTY STANDARDS AND REGULATIONS. THE ENGINEERING DEPARTMENT SHALL BE NOTIFIED A MINIMUM OF 24 HOURS IN ADVANCE FOR SCHEDULING OF AN
- 8. ROOF DRAINS, FOUNDATION DRAINS AND OTHER CLEAN WATER CONNECTIONS TO THE SANITARY SEWER ARE PROHIBITED.
- 9. CONTRACTOR SHALL VERIFY THE LOCATION AND INVERTS OF ALL EXISTING UTILITIES PRIOR TO CONSTRUCTION.
- 10. THE CONTRACTOR SHALL COORDINATE ALL UTILITY CONNECTIONS AND SHUT-OFFS WITH UTILITY PROVIDERS.
- 11. THE CONTRACTOR SHALL COORDINATE THE ARCHITECTURAL ROOF DRAIN LOCATIONS WITH THE SITE PLAN AND OUTLET THEM INTO THE NEAREST INLET BOX.

#### SANITARY SEWER NOTES

- 1. SANITARY SEWER LATERAL SHALL BE 6" DIAMETER OF PVC ASTM D-3034, SDR-35 WITH RUBBER GASKET JOINTS OR APPROVED EQUAL. LATERALS SHALL BE CONSTRUCTED WITH MINIMUM 1.0%
- 2. SANITARY SEWER MAINS SHALL BE 8" DIAMETER OF PVC ASTM D-3034, SDR-35 WITH RUBBER GASKET JOINTS OR APPROVED EQUAL. LATERALS SHALL BE CONSTRUCTED WITH MINIMUM 1.0% SLOPE AND HAVE A MINIMUM OF 4'-0" COVER.
- 3. ROOF DRAINS, FOUNDATION DRAINS AND OTHER CLEAN WATER CONNECTIONS TO THE SANITARY SEWER ARE PROHIBITED.
- 4. SANITARY SEWERS SHALL BE TESTED BY LOW PRESSURE AIR TESTS AND/OR OTHER TESTS AS REQUIRED BY THE AUTHORITY.
- 5. MANHOLE LIDS SHALL BE EQUIPPED WITH SELF-SEALING GASKETS.
- 6. SANITARY SEWER MANHOLES SHALL BE VACUUM TESTED.
- 7. THE MUNICIPAL AUTHORITY WILL INSPECT ALL SANITARY SEWER LINES AND LATERALS.
- 8. THE CONTRACTOR SHALL INSTALL NEW SANITARY SEWER LATERALS FROM THE BUILDING TO THE SANITARY SEWER MAIN LINE. EXISTING LATERALS UNDER EXISTING ROADS MAY BE USED, BUT THEY MUST BE VIDEOED AND LINED IN ACCORDANCE WITH THE AUTHORITY'S REQUIREMENTS.

### **ELECTRIC/TELEPHONE/CABLE NOTES:**


- 1. CONTRACTOR SHALL COORDINATE WITH RESPECTIVE UTILITY PROVIDER FOR CONDUIT SIZE, DEPTH REQUIREMENTS, NUMBER OF CONDUITS, PULL ROPE, TRACER WIRE AND BACKFILL REQUIREMENTS.
- 2. CONTRACTOR SHALL OBTAIN PERMITS AND CONTACT THE UTILITY COMPANY FOR VERIFICATION AND LOCATION OF HOOK-UP PRIOR TO ANY WORK BEING DONE.
- 3. SITE CONTRACTOR RESPONSIBLE FOR CONDUIT INSTALLATION ONLY.
- 4. CONTRACTOR SHALL COORDINATE WITH ARCHITECTURAL DRAWINGS PRIOR TO CONSTRUCTION TO VERIFY UTILITY STUB-OUT LOCATIONS.
- 5. ALL CONDUIT PIPE SHALL BE SCH40 BELOW GRADE, GLUED, CLEANED AND PLUGGED TO KEEP WATER AND DIRT OUT. CONTRACTOR SHALL INSTALL 1/4-INCH UNBROKEN NYLON OR POLYPROPYLENE PULL ROPE INSIDE EACH
- 6. MINIMUM CLEARANCE BETWEEN CONDUITS SHALL BE NO LESS THAN 1.0FT
- 7. MINIMUM DEPTH SHALL BE PER NEC STANDARDS WITH BURIED CONDUIT

# CONTRACTOR TO PERFORM PRIOR TO

CONTRACTOR TO FIELD LOCATE OWNER AND ENGINEER IMMEDIATELY OF

# ANY ON SITE CONSTRUCTION

EXISTING UTILITY LINES AND ALERT ANY CONFLICTS RELATED TO THE INSTALLATION OF THE PROPOSED UNDERGROUND UTILITIES.

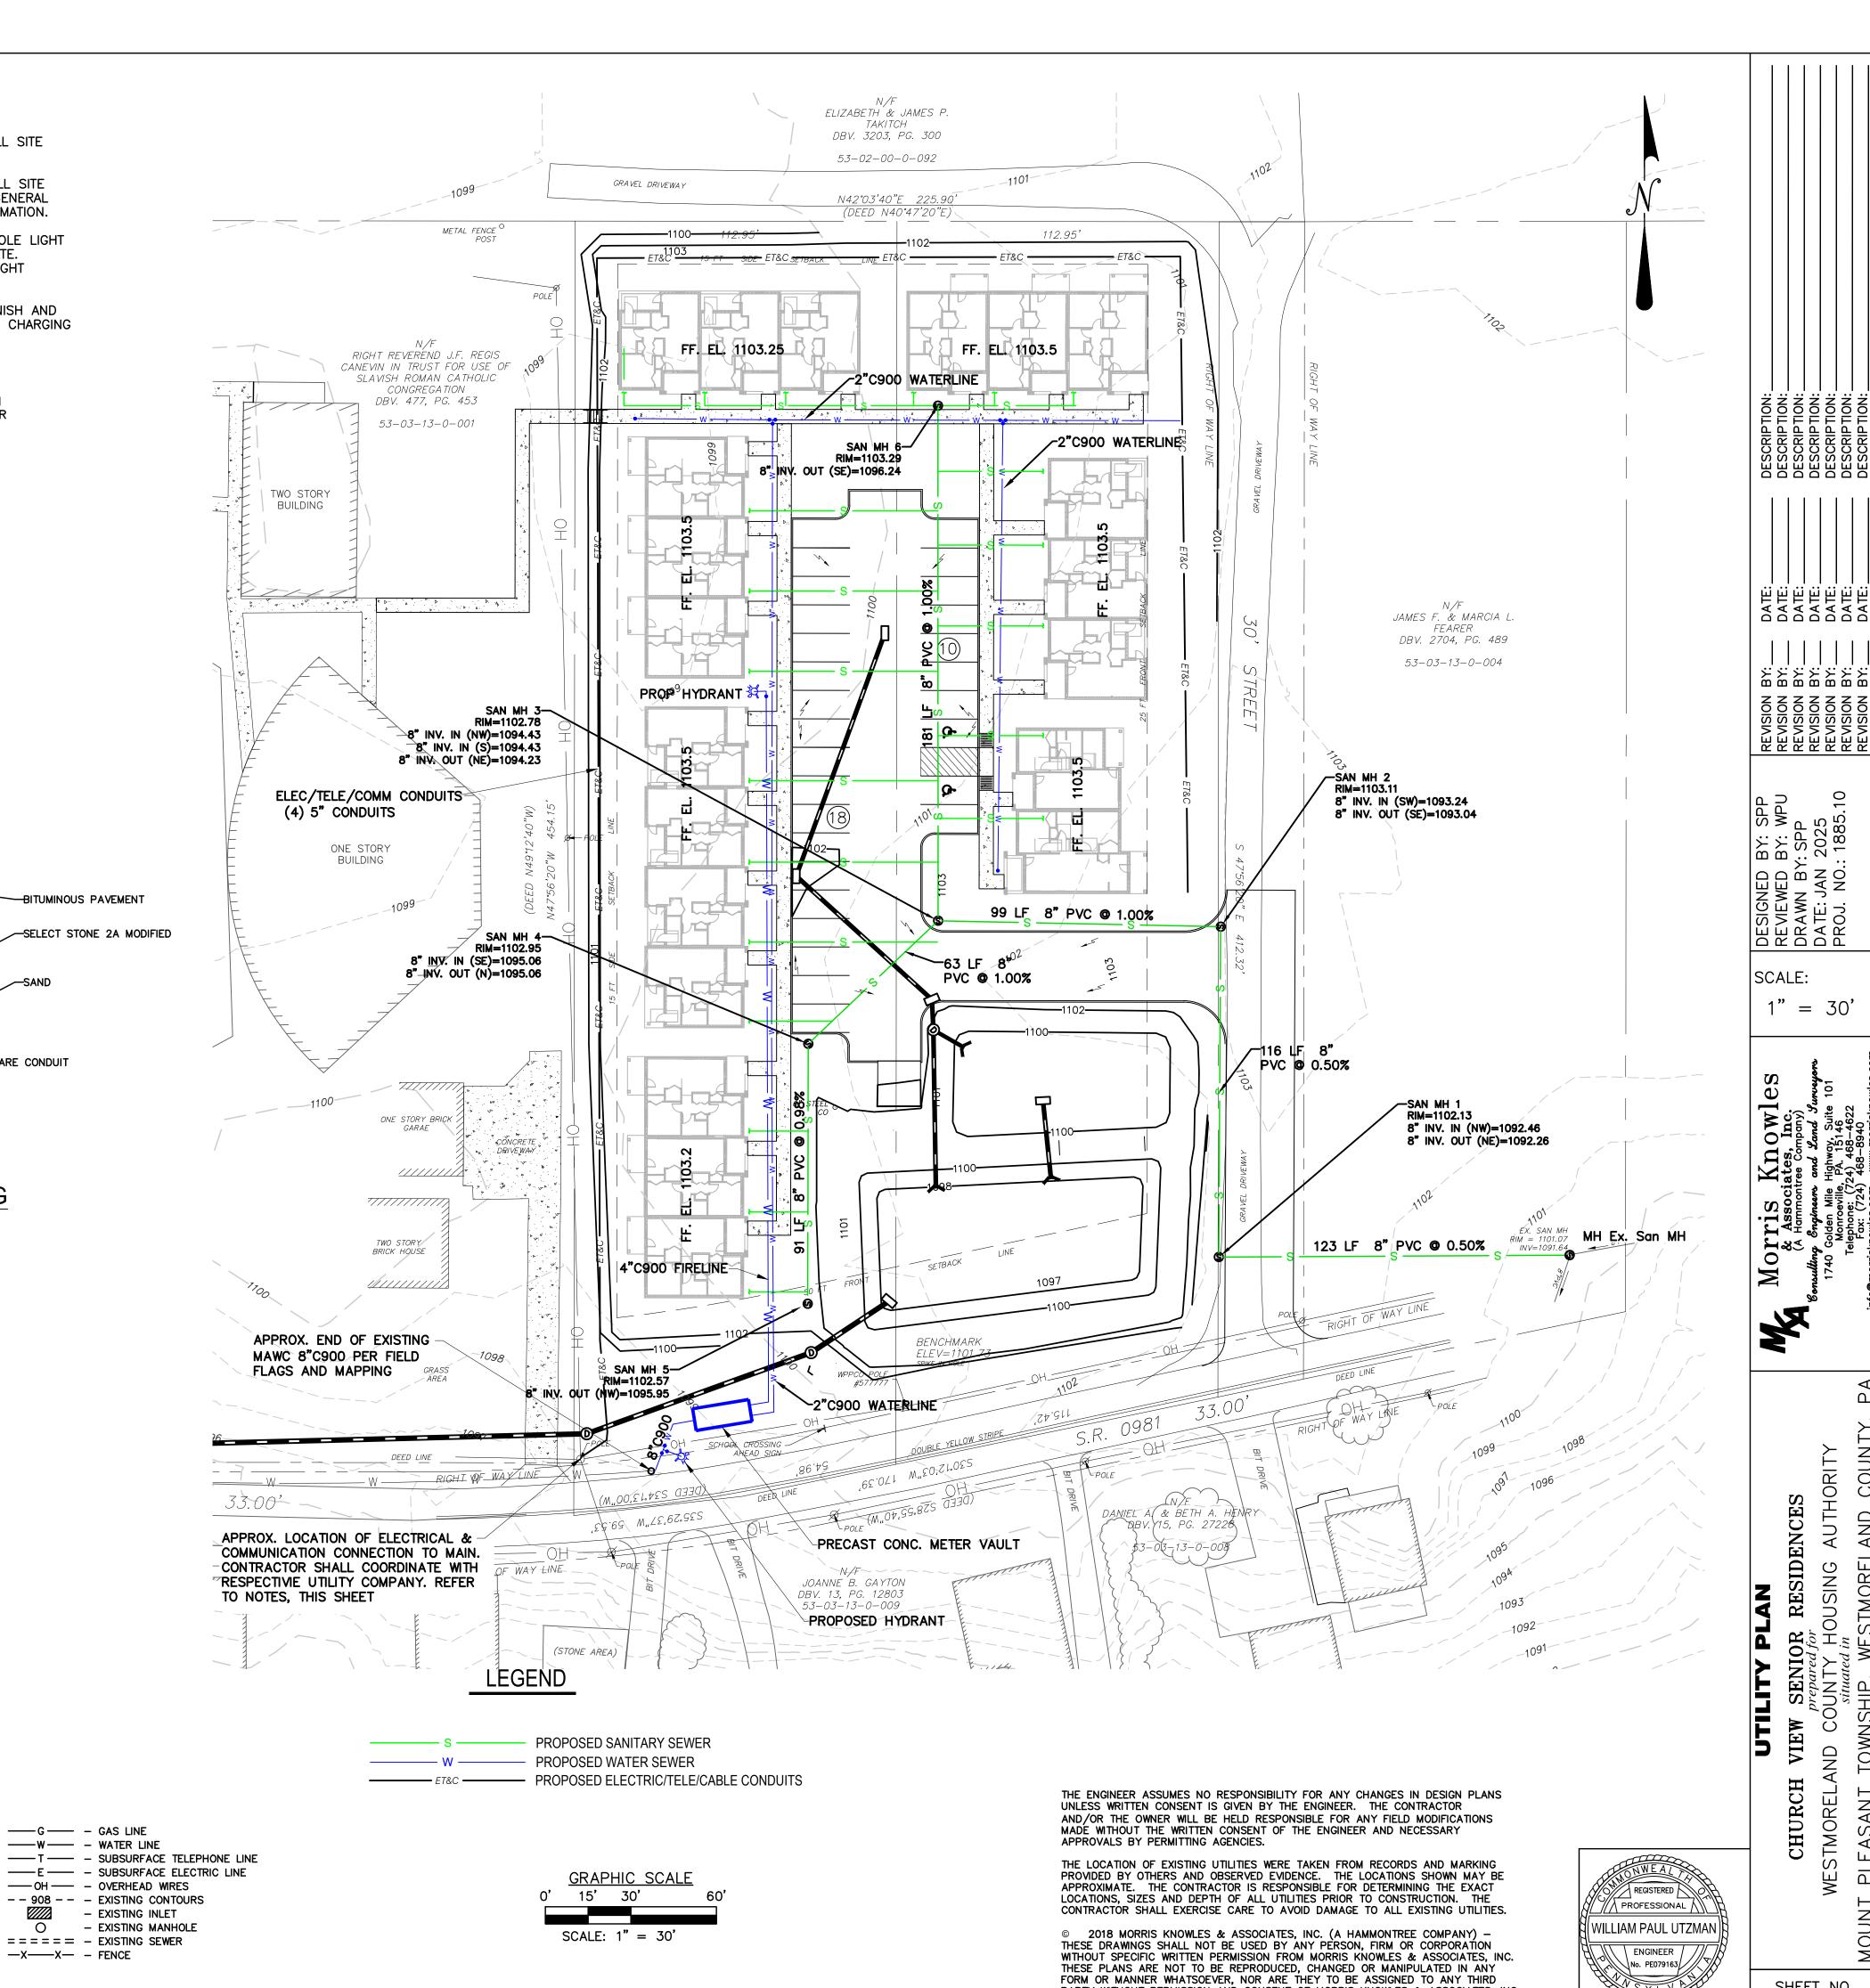

SHEET NO.

C400


PARTY WITHOUT PERMISSION AND CONSENT OF MORRIS KNOWLES & ASSOCIATES, INC.

CALL BEFORE YOU DIG IN PENNSYLVANIA 1-800-242-1776 Know what's below DESIGN SN: 20241833199 Call before you dig

THE GENERAL CONTRACTOR SHALL NOTIFY ALL UTILITY COMPANIES INVOLVED IN THE SITE NO MORE TEN DAYS AND NO LESS THAN THREE DAYS IN ADVANCE OF EXCAVATION (PA ACT 287 OF 1974 AMENDED BY ACT 50 OF 2018). PA STATE LAW REQUIRES 3 WORKING DAYS NOTICE

# SANITARY PROFILE: EXIST SAN MH TO MH 6

SCALE: HORIZ. 1"=30' VERT. 1"=10'

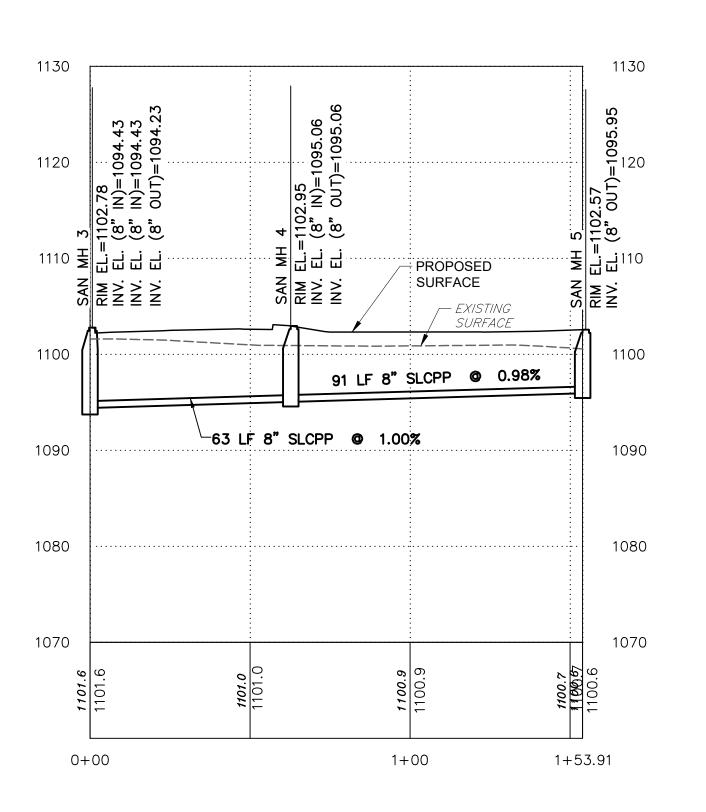

SANITARY PROFILE: SAN MH3 TO MH 6

SCALE: HORIZ. 1"=30' VERT. 1"=10'

Know what's below DESIGN SN: 20241833199 Call before you dig

THE GENERAL CONTRACTOR SHALL NOTIFY ALL UTILITY COMPANIES INVOLVED IN THE SITE NO MORE TEN DAYS AND NO LESS THAN THREE DAYS IN ADVANCE OF EXCAVATION (PA ACT 287 OF 1974 AMENDED BY ACT 50 OF 2018). PA STATE LAW REQUIRES 3 WORKING DAYS NOTICE

CALL BEFORE YOU DIG


IN PENNSYLVANIA

1-800-242-1776

THE ENGINEER ASSUMES NO RESPONSIBILITY FOR ANY CHANGES IN DESIGN PLANS UNLESS WRITTEN CONSENT IS GIVEN BY THE ENGINEER. THE CONTRACTOR AND/OR THE OWNER WILL BE HELD RESPONSIBLE FOR ANY FIELD MODIFICATIONS MADE WITHOUT THE WRITTEN CONSENT OF THE ENGINEER AND NECESSARY APPROVALS BY PERMITTING AGENCIES.

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SHEET NO.

RESIDENCES
HOUSING AUTHORITY
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DATE: DATE: DATE: DATE: DATE: DATE:

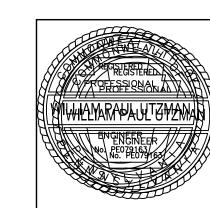DESIGN REVIEN DRAWN DATE: PROJ.

1" = 30'


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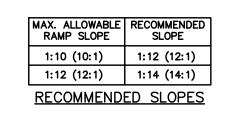
Knowles iates, Inc.

Morris & Associa (A Hammontr

CHURCH WESTMORELA

C401




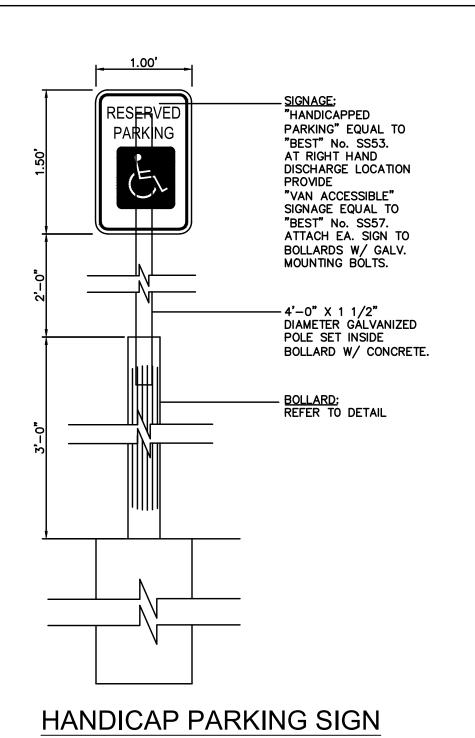

MAX. ALLOWABLE RAMP SLOPE	MAX. ALLOWABLE RAMP SLOPE	RECOMMENDED SLOPE
LESS THAN OR EQUAL TO 3"	1:8 (8:1)	1:8 (8:1)
LESS THAN OR EQUAL TO 6"	1:10 (10:1)	1:10 (10:1)
GREATER THAN 6"	1:12 (12:1)	1:12 (12:1)
ALLOWABLE ALTERAT	TIONS TO RAM	IP SLOPES


THE LEAST POSSIBLE SLOPE IS USED FOR ALL CURB RAMPS. HOWEVER FOR ALTERATIONS WHERE SPACE IS LIMITED, THE RAMP SLOPE MAY BE STEEPENED. THE CHART ABOVE DEPICTS THE MAXIMUM ALLOWABLE SLOPE THAT MAY BE USED.

> 1:12 (12:1) MAX RAMP SLOPE 8% MAX CHANGE IN GRADE BETWEEN ROAD

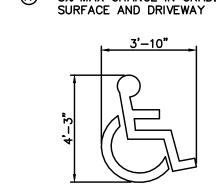

SYMBOL SHALL BE PAINTED WITH BLUE PAVEMENT MARKING STRIPPING PAINT

HANDICAP SYMBOL

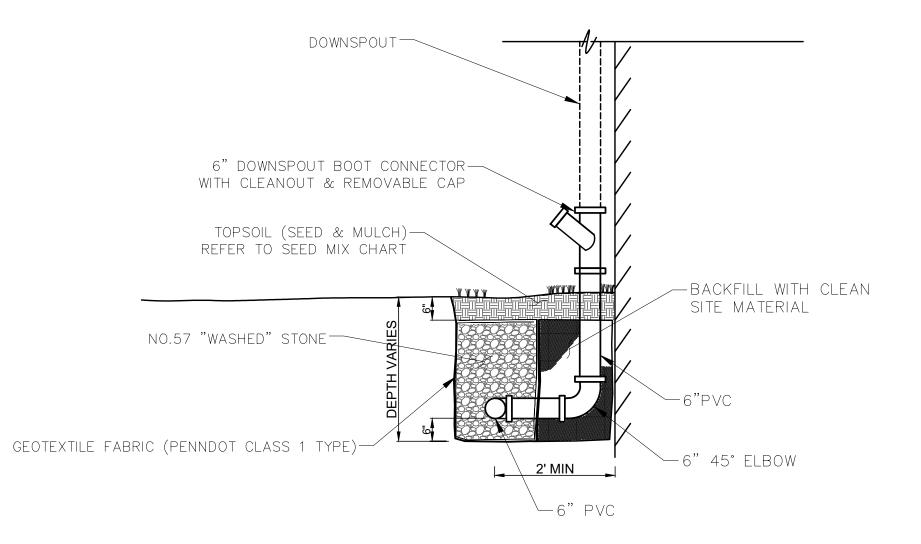


TYPICAL DOWNSPOUT CONNECTION

N.T.S.

NOTES:

- 1. PROVIDE MATERIALS AND CONSTRUCTION MEETING THE REQUIREMENTS OF PUBLICATION 408, SECTIONS 350, 409, 630,
- 2. PROVIDE EXPANSION JOINT MATERIAL 13 (1/2") THICK WHERE CURB RAMP ADJOINS ANY RIGID PAVEMENT, SIDÈWALK OR STRUCTURE WITH THE TOP OF JOINT FILLER FLUSH WITH ADJACENT CONCRETE
- 3. SEAL JOINTS WITH AN APPROVED SEALING MATERIAL.
- 4. PROVIDE SLIP RESISTANT TEXTURE ON CURB RAMP BY COARSE BROOMING TRANSVERSE TO THE SLOPE OF THE RAMP. EXTEND TEXTURE THE FULL WIDTH AN LENGTH OF THE CURB RAMP INCLUDING FLARED SIDE RAMPS.
- 5. MODIFY CONSTRUCTION DETAILS TO ADAPT DIMENSIONS TO EXISTING CURB ALTERATIONS WHERE THE CURB IS LESS THAN THE STANDARD 200 (8") HEIGHT.
- 6. CURB RAMP AND SIDE FLARE LENGTHS ARE VARIABLE AND BASED ON CURB HEIGHT AND THE SIDEWALK SLOPE.
- 7. IT MAY BE NECESSARY TO LIMIT THE RUN OF PARALLEL OR PERPENDICULAR RAMP IN ORDER TO AVOID CHASING GRADE INDEFINITELY. RAMP LENGTH NOT TO EXCEED 15'-0", ADJUST RAMP SLOPE AS NEEDED.
- 8. WHENEVER POSSIBLE, CONSTRUCT THE TRANSITION SLOPE FROM THE CURB RAMP AND FLARE SIDES TO ADJOINING SURFACES WITH A GRADUAL ROUNDED SHAPE RATHER THAN AN ABRUPT ANGLE.
- ENSURE CONSTRUCTION IS WITHIN MAXIMUM SLOPE. 9. CONSTRUCT BUILT-UP CURB RAMP OF BITUMINOUS MATERIAL AS INDICATED, INCLUDING SURFACE PREPARATION AND TACK COAT, AS
- 10. ALIGN DETECTABLE WARNING DOMES ON A SQUARE GRID IN THE PREDOMINANT DIRECTION OF PEDESTRIAN TRAVEL.
- 11. PROVIDE DETECTABLE WARNING SURFACES THAT CONTRAST VISUALLY WITH ADJACENT WALKWAY SURFACES, EITHER LIGHT-ON-DARK OR DARK-ON-LIGHT FOR THE FULL WIDTH OF THE
- 12. NOWHERE SHALL THE CROSS SLOPE OF THE RAMPS ACCESSIBLE ROUTE EXCEED 2%.
- 13. CONSTRUCT RAMP AND FLARE SLOPES WITH THE FLATTEST SLOPE POSSIBLE. THE SLOPES INDICATED IN THE DETAILS SHOW THE MAX SLOPE ALLOWABLE. IT IS STRONGLY RECOMMENDED TO USE THE FOLLOWING SLOPES TO ALLOW FOR CONSTRUCTION TOLERANCES.


-CONCRETE CURB

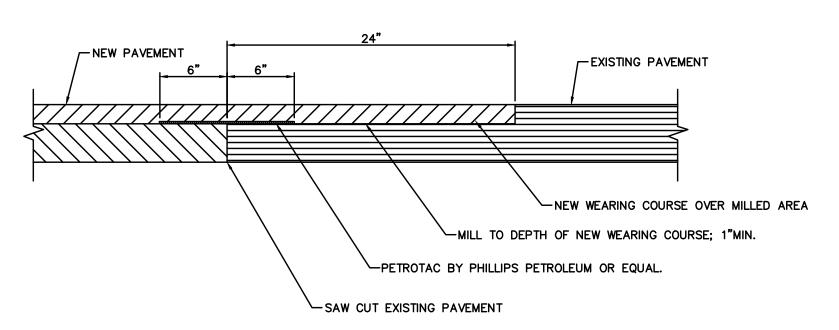


#### PAVING NOTES:

- 1. IF SUBGRADE MATERIALS ARE UNSUITABLE, CONTRACTOR SHALL EXCAVATE TO SUITABLE MATERIAL, FILL AND COMPACT TO PENNSYLVANIA DEPARTMENT OF TRANSPORTATION SPECIFICATIONS.
- 2. CONTRACTOR SHALL INSTALL AND COMPACT SUBBASE ACCORDING TO PENNSYLVANIA DEPARTMENT OF TRANSPORTATION SPECIFICATIONS AND IN LIFTS NO MORE THAN 2" TO 3".
- 3. TACK COAT SHALL BE APPLIED AS NECESSARY BETWEEN ALL COURSES OF FLEXIBLE PAVEMENT
- 4. CONTRACTOR SHALL PROVIDE 10' OF ROUNDING ON CHANGES OF GRADE IN DRIVEWAYS. 5. CONTRACTOR SHALL VERIFY PAVEMENT DESIGN AND CONSULT THE ENGINEER WHEN PROPER SOIL TESTS AND EVALUATIONS ARE PERFORMED. THE PAVEMENT DESIGN BELOW WAS BASED UPON THE GEOTECH'S RECOMMENDATIONS.
- 6. CONTRACTOR SHALL COMPACT THE SUBGRADE TO AT LEAST 98% OF THE MAXIMUM DENSITY IN ACCORDANCE WITH ASTM D-698. THE SUBGRADE SHALL BE IN A STABLE, NON-YIELDING CONDITION AT THE TIME OF PAVING.
- 7. THE CONTRACTOR SHALL PROOF ROLL THE SUBGRADE OF ALL AREAS SCHEDULED FOR PAVEMENT REPLACEMENT PRIOR TO PLACING GEOTEXTILE FABRIC.

## PAVEMENT CONNECTION - PROPOSED TO EXISTING

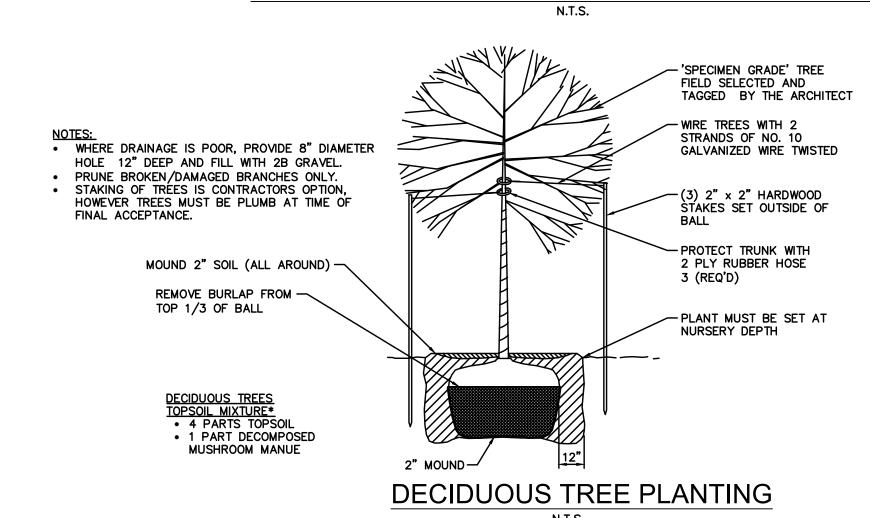

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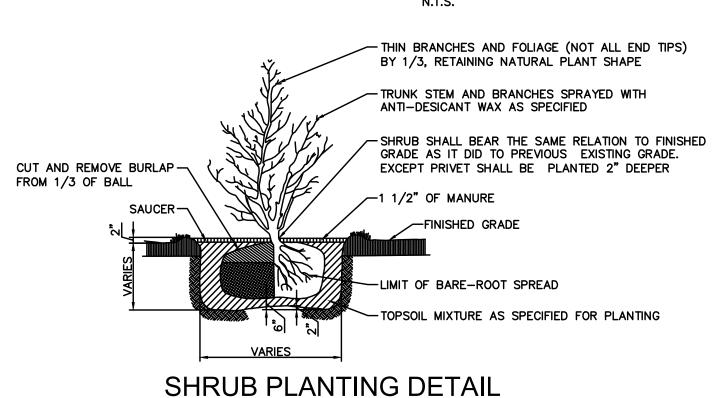

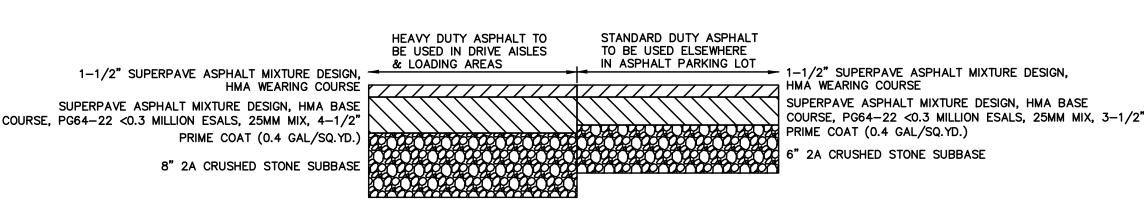
## ASPHALTIC CONCRETE PAVEMENT DETAIL

1.5" SUPERPAVE ASPHALT MIXTURE DESIGN, HMA WEARING COURSE (FINAL TOP COAT, SPRING) TACK/PRIME COAT AND PENNDOT PAVING FABRIC PRIOR TO PLACEMENT MODERATE DUTY ASPHALT -SUPERPAVE ASPHALT MIXTURE DESIGN, HMA BASE COURSE, PG64-22 <0.3 MILLION ESALS, 25MM MIX, 3-1/2" PRIME COAT (0.4 GAL/SQ.YD.) 

\_ 6" 2A CRUSHED STONE SUBBASE


### ASPHALTIC CONCRETE PAVEMENT DETAIL



 WHERE DRAINAGE IS POOR, PROVIDE 8" DIAMETER HOLE 12" DEEP AND FILL WITH 2B GRAVEL. • PRUNE BROKEN/DAMAGED BRANCHES ONLY. PLANT MUST BE SET AT -NURSERY DEPTH -STAKING OF TREES IS CONTRACTORS OPTION, REMOVE BURLAP FROM -HOWEVER TREES MUST BE PLUMB AT TIME OF FINAL TOP 1/3 OF BALL ACCEPTANCE EVERGREEN TREES
TOPSOIL MIXTURE\*

• 4 PARTS TOPSOIL • 1 PART HUMUS **EVERGREEN TREE PLANTING** 

# DEPRESSED CURB FLUSH WITH PAVEMENT GUTTER LINE \_ PAVEMENT GUTTER Lo" AT CURB CUTS 2" AT CURB TERMINATIONS DEPRESSED CURB AND CURB TAPER DETAIL

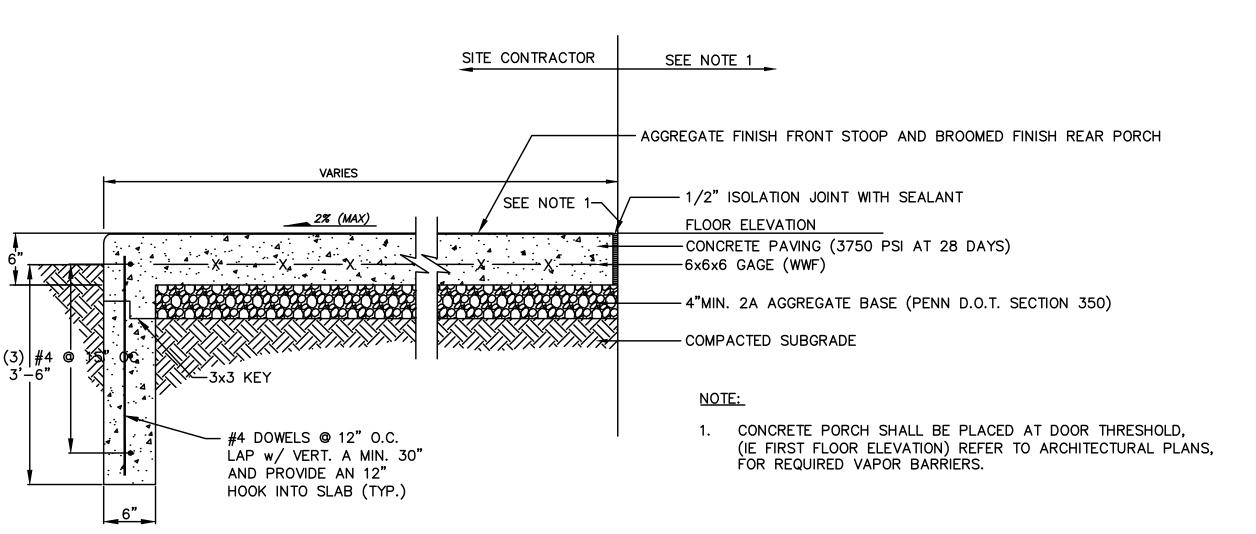

## CONCRETE STOOP / FROST WALL TYPICAL DETAIL

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FORM OR MANNER WHATSOEVER, NOR ARE THEY TO BE ASSIGNED TO ANY THIRD PARTY WITHOUT PERMISSION AND CONSENT OF MORRIS KNOWLES & ASSOCIATES, INC.

REGISTERED PROFESSIONAL WILLIAM PAUL UTZMAN ENGINEER No. PE079163

SHEET NO. C600

**R R R R R R R** 


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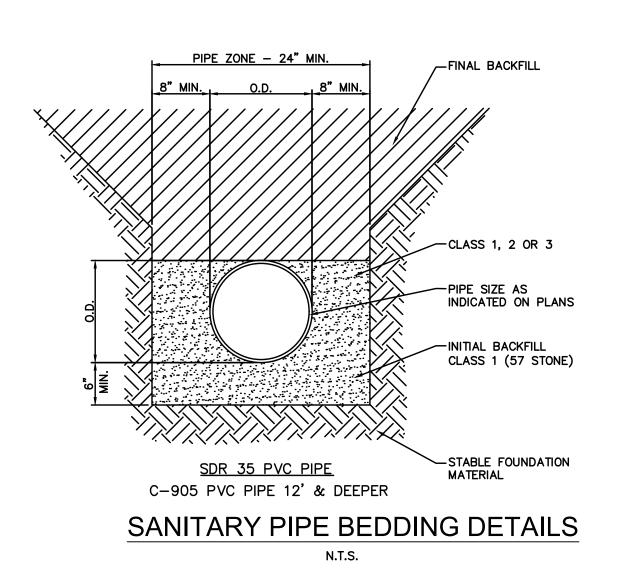
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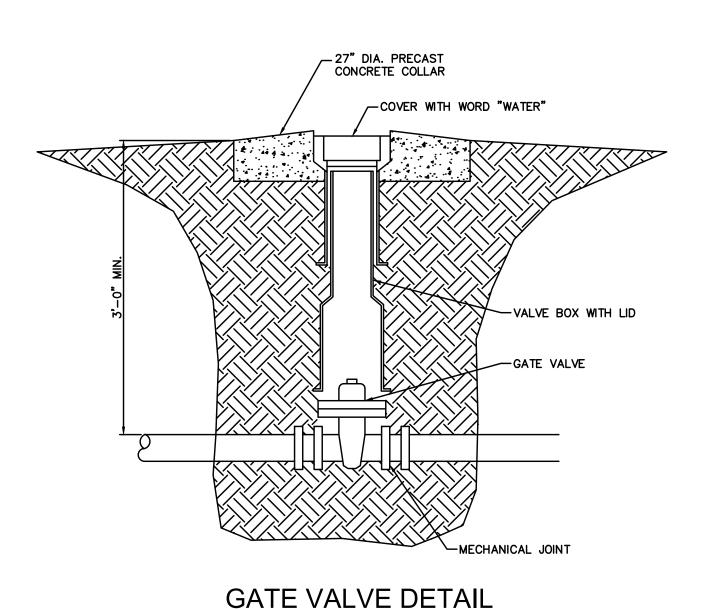
Morris & Ass (A Ham


RESIDENCES

SING





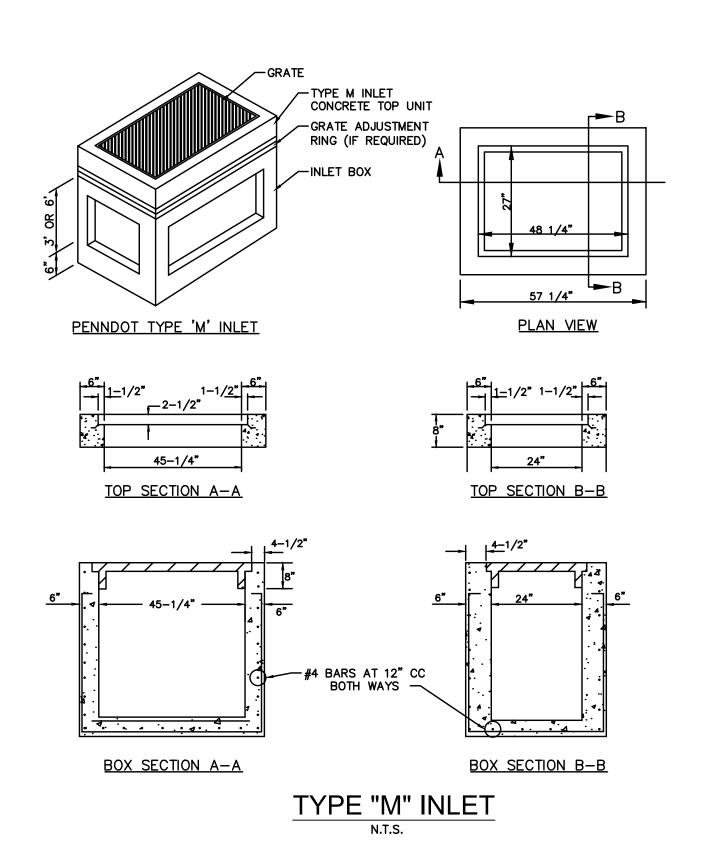

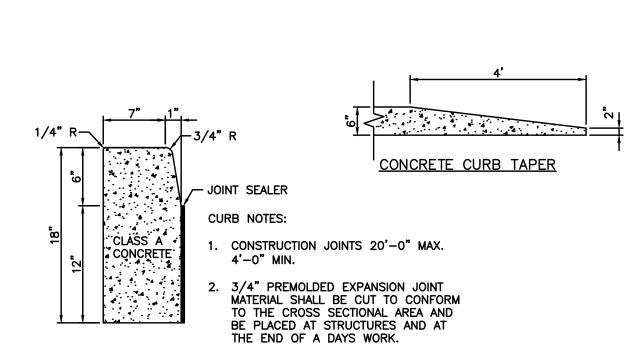

JOINT NOTES:

MANUFACTURER.

-1/2" x 4"

JOINT MATERIAL

REF: www.jdrussellco.com

1. JOINTS SHALL BE TOOLED, NOT SAWCUT.

RUBBER"REFLEX"OR EQUAL EXPANSION

-1/2"x12" DIA. SMOOTH DOWEL BARS GREASED (SPACE 10" ON CENTER)

8" GARBAGE PICKUP

8" COMPACTED AGGREGATE

2. JOINT FILLER MATERIAL (@ ALL ISOLATION JOINTS) SHALL BE

PENNDOT PUBLICATION 408. FOAM BACKER ROD (@ ALL

RUBBER "FEFLEX" OR APPROVED EQUAL, IN ACCORDANCE W/

CONTRACTION JOINTS) SHALL BE MANUFACTURED FOR USE IN PAVEMENT AND WALKWAY JOINTS BY THE JOINT SEALANT

3. W.C.H.A. RESERVES THE RIGHT TO DISASSEMBLE ONE (1) ISOLATION

TO DETERMINE COMPLIANCE WITH CONTRACT REQUIREMENTS.

AND ONE (1) CONTRACTION JOINT AT THE CONTRACTOR'S EXPENSE

-1/2" x 4"

JOINT MATERIAL

REF: www.jdrussellco.com

RUBBER"REFLEX"OR EQUAL EXPANSION

1/2"x12" DIA. SMOOTH DOWEL BARS

GREASED (SPACE 10" ON CENTER)

4" SIDEWALK


6" WALKWAY

**AGGREGATE** 


N.T.S.

## PENNDOT PLAIN CEMENT **CONCRETE CURB**

N.T.S.

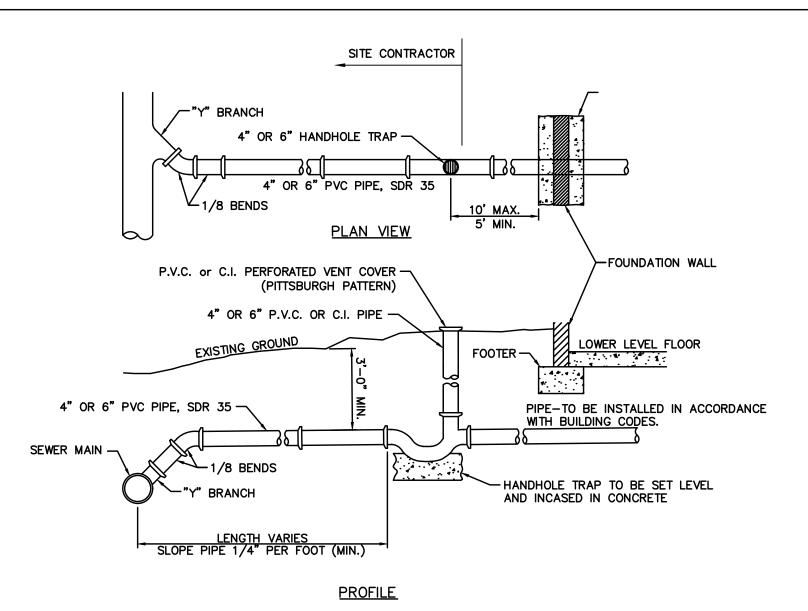

# SANITARY SEWER SERVICE LATERAL AT BUILDING

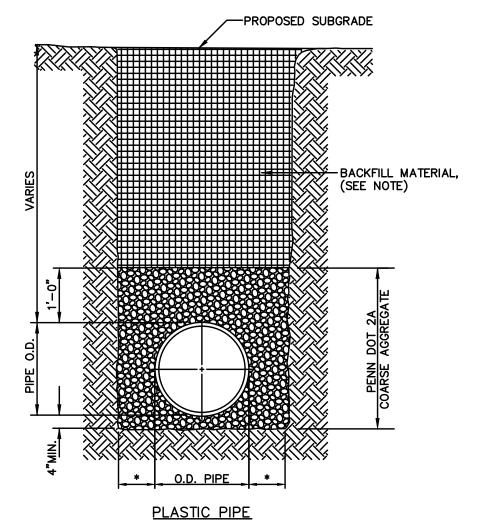

O.D. — OUTSIDE PIPE DIAMETER \* 12" IN PENNDOT R.O.W. 8" MIN. IN ALL OTHER CONDITIONS

## STORM SEWER STANDARD TRENCHING

2'-6" ON CENTER

BLUE

PARKING SPACE LINE PAINTING (TYP.)
N.T.S.

HANDICAP -

HANDICAP -


ALL STREET, SIDEWALK AND PARKING AREA CROSSINGS SHALL BE BACKFILLED TO SUBGRADE WITH AASHTO #57 AGGREGATE, GRAVEL OR STONE FOR SEWERS AND 2A LIMESTONE FOR ALL OTHER UTILITIES.

IN ALL OTHER TRENCH AREAS; BACKFILL FROM THE SPRINGLINE TO (1) ONE FOOT ABOVE THE TOP OF PIPE, TO BE SELECTED MATERIAL (SELECTED MATERIAL IS FINELY DIVIDED MATERIAL FREE OF DEBRIS, ORGANIC MATERIAL AND STONES.), TAMPED IN (4) FOUR INCH LAYERS; THEN THE REMAINING BACKFILL FROM THE TRENCH MAY BE PLACED. IF UNSUITABLE BACKFILL IS DETERMINED TO BE PRESENT BY THE OWNER REPRESENTATIVE, IMPORTED BACKFILL WILL BE REQUIRED.

# MULCH & RESEED GRASSY AREAS. REPAIR & REPLACE PAVED AREAS TO MATCH ORIGINAL MATERIAL. TRACER TAPE -SELECT BACK FILL IN NON-TRAFFIC AREAS 2 RC BACK FILL UNDER DRIVES OR PAVED -1/4" TO 3/4" COMPACTED STONE PLACED IN 4" LIFTS. -GRANULAR BEDDING

PROVIDE AN ELECTRICALLY CONTINUOUS TYPE TW. INSULATED. NUMBER 14 TRACER WIRE IN THE TRENCH 23 INCHES ABOVE THE PIPE AND TERMINATING ABOVE GROUND WITH A 2 INCH LEAD TAPED AROUND EACH RISER OR VALVE.

## TYPICAL WATERLINE TRENCH DETAIL

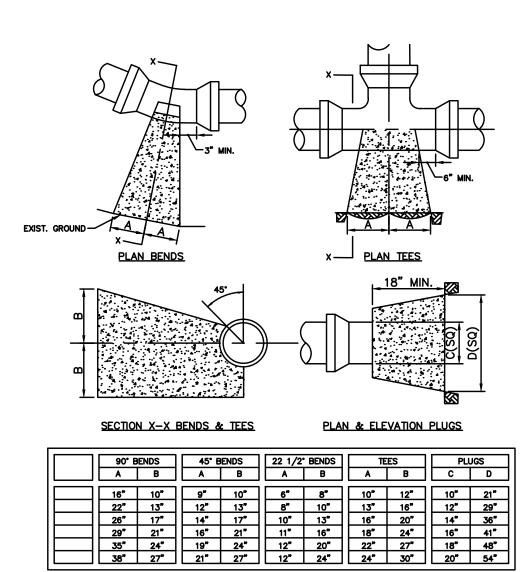

NOTE: Based on 1.5 X working pressure of 100 PSI plus AWWA Water Hammer. All bearing surfaces to be carried to undisturbed ground. STANDARD THRUST BLOCK FOR WATER MAINS


- WHERE GRADE ELEVATIONS ARE SHOWN, A UNIFORM SLOPE SHALL EXIST BETWEEN GIVEN ELEVATIONS.
- 2. THE TOP AND BOTTOM OF ALL SLOPES SHALL BE ROUNDED OFF TO SMOOTH CURVES.
- 3. THE HIGH AND LOW POINTS ON CURBS, WALKS, AND ROADS SHALL BE ROUNDED OFF TO SHOW NO DEFINITE CHANGE OF GRADE.
- 4. WALKS SHALL HAVE A MINIMUM CROSS-SLOPE OF AN 1/8" PER FOOT AND A MAXIMUM OF 1/4" PER FOOT UNLESS NOTED OTHERWISE, REINFORCE ALL CONCRETE WALKS, PLATFORMS, STOOPS, ETC. WITH 6x6x#6 MESH.
- 5. ALL CONCRETE SIDEWALKS SHALL BE SCORED IN INDIVIDUAL SECTIONS WITH THE LENGTH OF EACH SECTION EQUAL TO THE WIDTH UNLESS NOTED
- 6. INSTALL 1/4"x5" ASPHALT IMPREGNATED PREMOULDED EXPANSION JOINTS IN ALL CONCRETE WALKS AT 18'-0" INTERVALS AND AT THE INTERSECTION(S) OF CURBS, STEPS, OTHER WALKS, DIFFERING MATERIALS, ETC., AND/OR AS DIRECTED BY THE ENGINEER.
- 7. INSTALL 1/4" THICK PREMOULDED EXPANSION JOINT IN NEW CURBS AT 18'-0" INTERVALS.


#### BE 4" WIDE PAINT THE ENGINEER ASSUMES NO RESPONSIBILITY FOR ANY CHANGES IN DESIGN PLANS UNLESS WRITTEN CONSENT IS GIVEN BY THE ENGINEER. THE CONTRACTOR AND/OR THE OWNER WILL BE HELD RESPONSIBLE FOR ANY FIELD MODIFICATIONS MADE WITHOUT THE WRITTEN CONSENT OF THE ENGINEER AND NECESSARY APPROVALS BY PERMITTING AGENCIES.


ALL STRIPING TO

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N.T.S.

# TYPICAL CONCRETE SIDEWALK

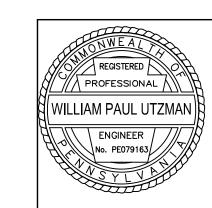- CONCRETE SIDEWALK TO BE 5 FT. WIDE UNLESS OTHERWISE NOTED.
- 2. CROSS SLOPE OF CONCRETE SIDEWALKS TO BE 2% MAX.
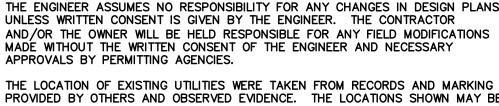
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# REINFORCING FOR GARBAGE PICK UP AREA TO BE

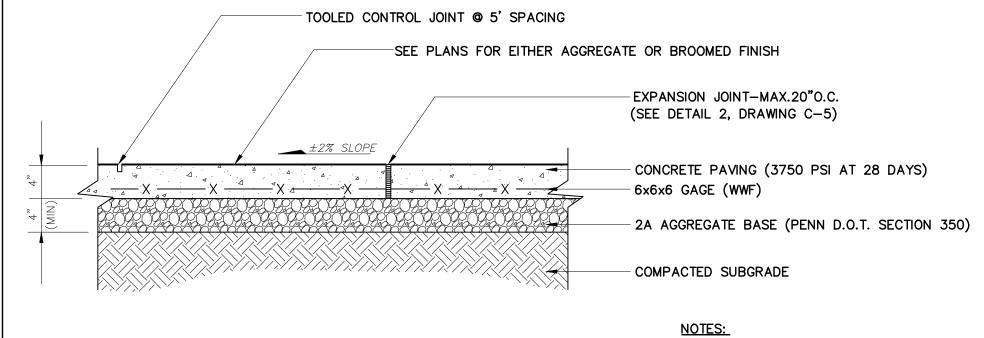6"x6" 10/10 WWF

## CONCRETE SIDEWALK EXPANSION JOINT

Morris & Ass (A Ham

RESIDENCES

SCALE:


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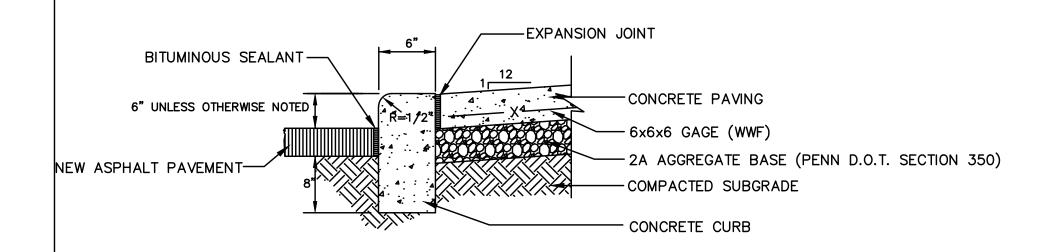
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C600


CONCRETE HANDICAP PARKING




CONCRETE CURB AT PAVEMENT AND SIDEWALK DETAIL

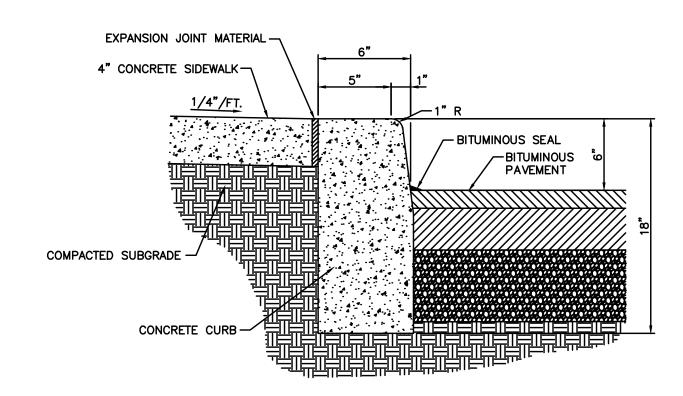


# **CURB & SIDEWALK DETAIL**

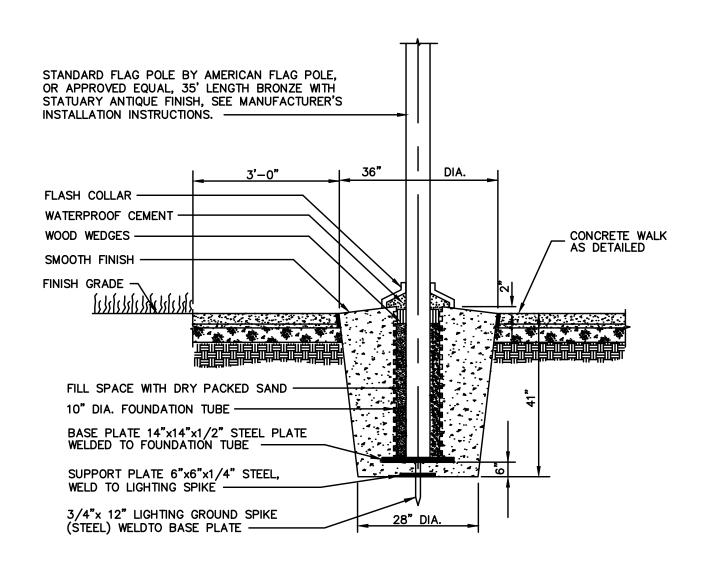

FLAG POLE BASE DETAIL

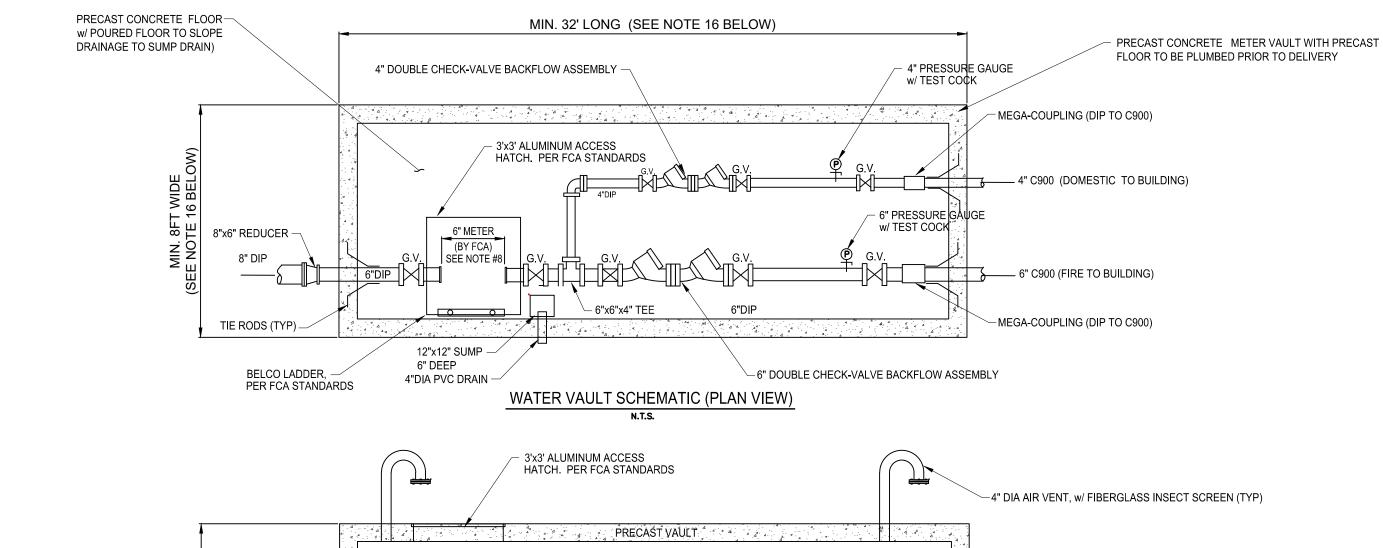


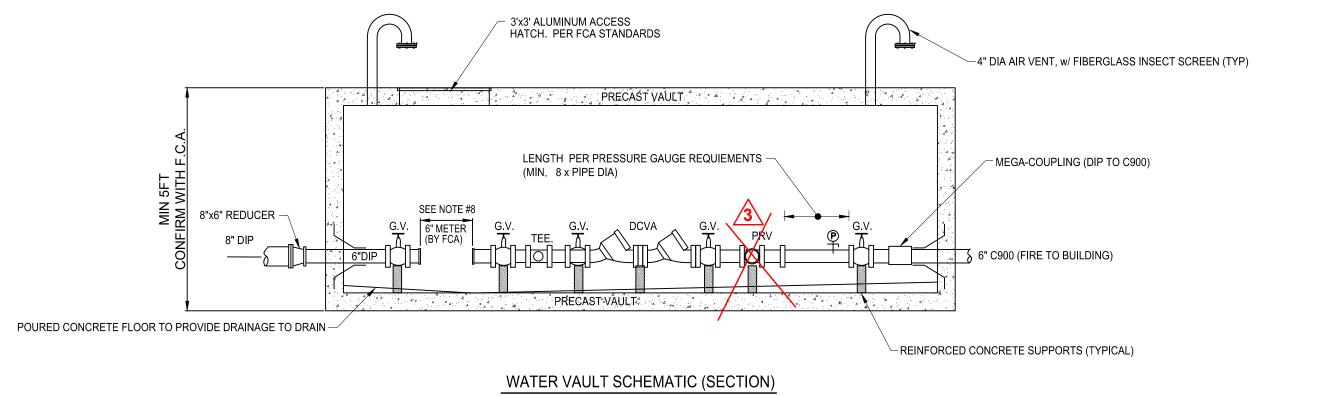

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DATE: DATE: DATE: DATE: DATE: DATE:

DA SPE

SCALE:

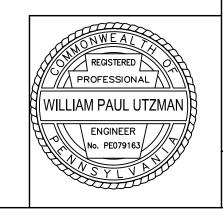rles

Morris & Assoc (A Hammo

SHEET NO. C602

SCALE: 1"=2000' USGS QUADRANGLE MAP MAMMOTH, PA

**EROSION AND SEDIMENTATION CONTROL TITLE** FINAL EROSION & SEDIMENTATION CONTROL PLAN **EROSION & SEDIMENTATION CONTROL DETAILS** 

WESTMORELAND COUNTY HOUSING AUTHORITY 167 S. GREENGATE RD. **GREENSBURG, PA 15601** PHONE NO.: 724-832-7248 **REP.: ERIK SPIEGEL** 

#### CHAPTER 93 RECEIVING WATER COURSE:

 THE RECEIVING WATER COURSE IS UNNAMED TRIBUTARY TO WELTY RUN WHICH IS DESIGNATED AS A HIGH QUALITY COLD WATER FISHES (HQ-CWF), BY THE PENNSYLVANIA DEPARTMENT OF ENVIRONMENTAL PROTECTION, CHAPTER 93.

#### MRC SWM #1 CONSTRUCTION SEQUENCE

- 1. INSTALL ALL SITE CONTROLS SUCH AS FILTER SOCKS PER THE APPROVED PLAN.
- 2. CONTRACTOR SHALL PERFORM THE SITE GRADING OF THE MRC SWM TO THE GRADES SHOWN.
- 3. THE MRC SWM SHALL BE EXCAVATED TO THE DEPTH OF THE BASIN INVERT (SUBGRADE DEPTH).
- THE SITE HAS BEEN PERMANENTLY GRADED AND ADEQUATE VEGETATION IS FULLY ESTABLISHED. IT IS ESSENTIAL THAT THE CONTRACTOR REACHES OUT TO THE OWNER TO SECURE AUTHORIZATION FROM THE OWNER'S ENGINEER. THIS AUTHORIZATION IS NECESSARY FOR CONDUCTING A THOROUGH SITE VERIFICATION TO CONFIRM THE PRESENCE OF PERENNIAL COVER, WHICH MUST OCCUR PRIOR TO COMMENCING THE CONSTRUCTION OF THE FINAL MRC SWM BASIN.

4. THE CONTRACTOR SHALL NOT INSTALL THE SOIL MEDIA, UNDERDRAIN, AND UPTURNED ELBOW UNTIL

- 5. PRIOR TO FINAL MRC SWM CONSTRUCTION, CONTRACTOR SHALL REMOVE ALL SEDIMENT WITHIN BASIN
- 6. UPON ENGINEER'S AUTHORIZATION, CONTRACTOR SHALL INSTALL THE MRC UNDERDRAIN, UPTURNED ELBOW, APPURTENANCES, AND SOIL MEDIA PER THE DESIGN PLANS. OVERFILLING IS RECOMMENDED TO ACCOUNT FOR SETTLEMENT. LIGHT HAND TAMP ONLY, IF NECESSARY
- 7. PLANT VEGETATION ACCORDING TO PLANTING PLAN.

#### SWM #2 CONSTRUCTION SEQUENCE

- INSTALL ALL SITE CONTROLS SUCH AS FILTER SOCKS PER THE APPROVED PLAN.
- 2. CONTRACTOR SHALL PERFORM THE SITE GRADING OF THE BASIN TO THE GRADES SHOWN.
- 3. THE BASIN SHALL BE EXCAVATED TO THE DEPTH OF THE BASIN INVERT (SUBGRADE DEPTH).
- 4. THE CONTRACTOR SHALL NOT INSTALL THE SOIL MEDIA, UNTIL THE SITE HAS BEEN PERMANENTLY GRADED AND ADEQUATE VEGETATION IS FULLY ESTABLISHED. IT IS ESSENTIAL THAT THE CONTRACTOR REACHES OUT TO THE OWNER TO SECURE AUTHORIZATION FROM THE OWNER'S ENGINEER. THIS AUTHORIZATION IS NECESSARY FOR CONDUCTING A THOROUGH SITE VERIFICATION TO CONFIRM THE PRESENCE OF PERENNIAL COVER, WHICH MUST OCCUR PRIOR TO COMMENCING THE CONSTRUCTION
- 5. PRIOR TO FINAL MRC SWM CONSTRUCTION, CONTRACTOR SHALL REMOVE ALL SEDIMENT WITHIN BASIN
- 6. UPON ENGINEER'S AUTHORIZATION, CONTRACTOR SHALL INSTALL SOIL MEDIA, AND APPURTENANCES, PER THE DESIGN PLANS. OVERFILLING IS RECOMMENDED TO ACCOUNT FOR SETTLEMENT. LIGHT HAND TAMP ONLY, IF NECESSARY

OF ANY OTHER INDIVIDUAL OR ENTITY PERFORMING ANY OF THE WORK.

1. THE ENGINEER ASSUMES NO RESPONSIBILITY FOR ANY CHANGES IN DESIGN PLANS UNLESS WRITTEN CONSENT IS GIVEN BY THE

OWNER. CONTRACTOR AND/OR OWNER WILL BE HELD RESPONSIBLE FOR ANY FIELD MODIFICATIONS MADE WITHOUT WRITTEN

2. ENGINEER WILL NOT SUPERVISE, DIRECT, CONTROL, OR HAVE AUTHORITY OVER OR BE RESPONSIBLE FOR CONTRACTOR'S MEANS,

CONSENT OF ENGINEER. ALL UTILITIES SHOWN ON PLANS ARE IN APPROXIMATE LOCATIONS BASED ON PA. ONE-CALL FLAGGING, OR AVAILABLE UTILITY MAPS. IT IS THE RESPONSIBILITY OF THE CONTRACTOR TO DETERMINE EXACT LOCATIONS AND DEPTH OF ALL

METHODS, TECHNIQUES, SEQUENCES, OR PROCEDURES OF CONSTRUCTION, OR THE SAFETY PRECAUTIONS AND PROGRAMS INCIDENT

THERETO, OR FOR ANY FAILURE OF CONTRACTOR TO COMPLY WITH LAWS AND REGULATIONS APPLICABLE TO THE PERFORMANCE OF

THE WORK. ENGINEER WILL NOT BE RESPONSIBLE FOR CONTRACTOR'S FAILURE TO PERFORM THE WORK IN ACCORDANCE WITH THE

3. ENGINEER WILL NOT BE RESPONSIBLE FOR THE ACTS OR OMISSIONS OF CONTRACTOR OR OF ANY SUBCONTRACTOR, ANY SUPPLIER, OR

PLANT VEGETATION ACCORDING TO PLANTING PLAN.

UTILITIES PRIOR TO ANY CONSTRUCTION.

**ENGINEER'S ROLE NOTES** 

# CHURCH VIEW SENIOR RESIDENCES

EROSION AND SEDIMENTATION CONTROL PLAN S.R. 981, MOUNT PLEASANT, WESTMORELAND COUNTY, PA

JANUARY 2025

OTHER APPROVED METHOD.

#### **CONSTRUCTION SEQUENCE:**

THE ENTIRE SITE CANNOT BE CLEARED AND GRUBBED AT ONE TIME. ONLY AREAS FOR WHICH THE SPECIFIED EROSION AND SEDIMENTATION CONTROL HAS BEEN INSTALLED CAN BE CLEARED AND GRUBBED OR DISTURBED.

#### STAGE 1: INSTALL ROCK CONSTRUCTION ENTRANCE AT STATE ROUTE 981

- A. CLEAR MINIMUM AREA NECESSARY FOR ENTRANCE INSTALLATION.
- B. EXCAVATE FOR, AND FORM ENTRANCE. IMMEDIATELY STABILIZE ENTRANCE WITH ROCK.

#### STAGE 2: INSTALL COMPOST FILTER SOCK

A. INSTALL COMPOST FILTER SOCK PER PLAN ON C701

#### **STAGE 3: CLEAR SITE**

- A. CLEAR SITE, CUT TRUNKS INTO TIMBER OR FIREWOOD AND CHIP BRANCHES ETC. LIMIT ADVANCED CLEARING AND GRUBBING AS MUCH AS POSSIBLE TO REDUCE THE AMOUNT OF AREA DISTURBED AT ANY ONE TIME. RECYCLING OF MATERIALS SHALL BE DONE
- 3. ONLY AREAS FOR WHICH THE SPECIFIED EROSION AND SEDIMENTATION CONTROL HAS BEEN INSTALLED CAN BE CLEARED AND GRUBBED OR DISTURBED.

#### STAGE 4: SOIL STOCKPILE #1

A. STRIP TOPSOIL FROM SITE AND PLACE IN DESIGNATED LOCATION. B. SHOULD CONTRACTOR NEEDS TO RELOCATE TO A DIFFERENT AREA ON-SITE TO EFFECTIVELY CARRY OUT THE WORK, IT IS ESSENTIAL THAT FILTER SOCKS ARE INSTALLED ALONG THE LOWER SIDE OF THE STOCKPILE. THIS PRECAUTION WILL HELP TO MITIGATE SEDIMENT RUNOFF AND PROTECT THE SURROUNDING ENVIRONMENT FROM POTENTIAL CONTAMINATION. THE PLACEMENT OF THESE FILTER SOCKS SHOULD BE DONE CAREFULLY TO ENSURE THEY ADEQUATELY CONTROL SEDIMENT FLOW DURING ALL PHASES OF THE PROJECT.

#### STAGE 5: EXCAVATION

- A. UPON COMPLETION OF THE ROCK CONSTRUCTION ENTRANCE AND INSTALLATION OF ALL PERIMETER CONTROLS, AND TOPSOIL STRIPPING, THE CONTRACTOR SHALL BEGIN EARTHMOVING ACTIVITIES.
- B. PERFORM SITE GRADING (CUT/FILL OPERATIONS) TO DESIGN GRADE. APPLY TEMPORARY STABILIZATION TO EMBANKMENTS AND FINISH GRADE AREAS IN CUT OR FILL.
- C. PLACE EROSION CONTROL BLANKET AS NOTED ON PLANS AFTER MATERIAL IS PLACED AND PROPERLY COMPACTED. D. ALL WATER PUMPED FROM WORK AREAS SHALL BE TREATED FOR SEDIMENT REMOVAL
- PRIOR TO DISCHARGING TO A SURFACE WATER. CONTRACTOR SHALL UTILIZE PUMPED WATER FILTER BAGS PER THE DETAIL ON PLAN SHEET C703.
- AS SOON AS DISTURBED AREA REACHES FINAL GRADE, AREAS MUST BE STABILIZED. 5. NO MORE THAN 15,000 SQUARE FEET OF DISTURBED AREA SHALL REACH FINAL GRADE BEFORE INITIATING SEED AND MULCHING OPERATIONS.
- G. FILL SLOPES SHALL BE STABILIZED IN 15 FOOT VERTICAL INCREMENTS.

### STAGE 6: INSTALL PROPOSED INFILTRATION BASIN

- A. PROTECT INFILTRATION BASIN AREA FROM COMPACTION PRIOR TO INSTALLATION. CONTRACTOR SHALL PREVENT COMPACTION WITHIN INFILTRATION AREA TO THE GREATEST EXTEND POSSIBLE. IN THE EVENT OF COMPACTION WITHIN THE INFILTRATION ZONE. THE CONTRACTOR SHALL SCARIFY THE SOIL TO PROMOTE INFILTRATION.
- PREPARE SITE FOR EXCAVATION AND/OR EMBANKMENT CONSTRUCTION. C. EXCAVATE BOTTOM OF BASIN TO DESIRED ELEVATION. IF NECESSARY, EXCAVATE INFILTRATION BOTTOM TO AN UNCOMPACTED SUBGRADE FREE FROM ROCKS AND DEBRIS. DO NOT COMPACT SUBGRADE.
- D. INSTALL OUTLET CONTROL STRUCTURE. COMPACT SURROUNDING EMBANKMENT AREA AND AROUND INLET AND OUTLET
- **STRUCTURES** F. APPLY AND GRADE PLANTING SOIL.
- G. SEED. PLANT, AND MULCH ACCORDING TO PLANTING PLAN.
- H. DO NOT REMOVE EROSION AND SEDIMENT CONTROL MEASURES UNTIL SITE IS FULLY
- \*\*THE CRITICAL STAGE FOR WHICH A LICENSED PROFESSIONAL OR DESIGNEE MUST BE ON-SITE IS FOR THE OUTLET STRUCTURE PRIOR TO BACKFILLING.\*\*

#### STAGE 7: INSTALL PROPOSED STORM SEWER SYSTEM

- A. INSTALL STORM SEWER SYSTEM FROM LOWEST TO HIGHEST ELEVATION AND ADHERE TO
- B. INSTALL STORM SEWER TRIBUTARY TO BIO-RETENTION SYSTEMS
- C. INSTALL INLET PROTECTION ON ALL INLETS IMMEDIATELY AFTER INSTALLATION. INLET PROTECTION SHOULD REMAIN UNTIL THE ENTIRE SITE HAS BEEN STABILIZED.

#### **STAGE 8: INSTALL PROPOSED UTILITIES**

A. INSTALL UTILITIES FROM LOWEST TO HIGHEST ELEVATION AND ADHERE TO UTILITY

#### STAGE 9: INSTALL BUILDINGS AND PAVEMENT A. PLACE CONCRETE WASHOUT AS INDICATED ON PLAN SHEET C701

B. CONSTRUCT BUILDINGS, AND PAVEMENT, CONCRETE CURBS, SIDEWALKS.

#### STAGE 10: INSTALL LANDSCAPING A. INSTALL LANDSCAPING PLANTS AND PROVISIONS.

STAGE 11: SEED AND MULCH A. SEED/MULCH ALL DISTURBED AREAS WITH SPECIFIED SEEDING MIXTURE. ALL E & S CONTROL FACILITIES SHALL BE MAINTAINED AND KEPT FUNCTIONAL UNTIL SITE

#### STABILIZATION IS COMPLETE.

- **STAGE 12: SITE STABILIZATION** A. WHEN SITE IS STABILIZED WITH UNIFORM 70% PERENNIAL VEGETATIVE COVER OVER
- PROJECT AREA, REMOVE EROSION AND SEDIMENTATION CONTROLS. B. DEWATER SEDIMENT TRAP #1 USING THE PUMP WATERING FILTERING DEVICE C. REMOVE ACCUMULATED SEDIMENT FROM THE SEDIMENT STORAGE ZONE AND SPREAD IN THE AREA PROTECTED BY SILT FENCE, SEED DISTURBED AREA PER PERMANENT SEEDING
- D. INSTALL 12" COMPOST FILTER SOCK DOWNSLOPE OF THE SEDIMENT TRAPS, RE-GRADE AREA TO ORIGINAL CONTOURS, SEED AND MULCH DISTURBED AREAS USING THE PERMANENT SEEDING MIXTURE.
- E. WHEN SEDIMENT TRAP AREA IS STABILIZED WITH UNIFORM 70% PERENNIAL VEGETATIVE COVER OVER PROJECT AREA, REMOVE EROSION AND SEDIMENTATION CONTROLS.

#### **EROSION AND SEDIMENTATION CONTROL PLAN NOTES:**

- FILLS SHALL BE DONE IN ACCORDANCE WITH THE APPROVED E&S PLAN. A COPY OF THE APPROVED DRAWINGS (STAMPED, SIGNED AND DATED BY THE REVIEWING AGENCY) MUST BE AVAILABLE AT THE PROJECT SITE AT ALL TIMES. THE REVIEWING AGENCY SHALL THOSE CHANGES. THE REVIEWING AGENCY MAY REQUIRE A WRITTEN SUBMITTAL OF THOSE CHANGES FOR REVIEW AND APPROVAL AT ITS DISCRETION.
- 2. AT LEAST 7 DAYS PRIOR TO STARTING ANY EARTH DISTURBANCE ACTIVITIES, INCLUDING CLEARING AND GRUBBING. THE OWNER AND/OR OPERATOR SHALL INVITE ALL CONTRACTORS, THE LANDOWNER, APPROPRIATE MUNICIPAL OFFICIALS, THE E&S PLAN PREPARER, THE PCSM PLAN PREPARER, THE LICENSED PROFESSIONAL RESPONSIBLE FOR OVERSIGHT OF CRITICAL STAGES OF IMPLEMENTATION OF THE PCSM PLAN, AND A REPRESENTATIVE FROM THE LOCAL CONSERVATION DISTRICT TO AN ON-SITE PRECONSTRUCTION MEETING.
- AT LEAST 3 DAYS PRIOR TO STARTING ANY EARTH DISTURBANCE ACTIVITIES. OR EXPANDING INTO AN AREA PREVIOUSLY UNMARKED, THE PENNSYLVANIA ONE CALL SYSTEM INC. SHALL BE NOTIFIED AT 1-800-242-1776 FOR THE LOCATION OF EXISTING UNDERGROUND UTILITIES.
- 4. ALL EARTH DISTURBANCE ACTIVITIES SHALL PROCEED IN ACCORDANCE WITH THE SEQUENCE PROVIDED ON THE PLAN DRAWINGS. DEVIATION FROM THAT SEQUENCE MUST BE APPROVED IN WRITING FROM THE LOCAL CONSERVATION DISTRICT OR BY THE DEPARTMENT PRIOR TO IMPLEMENTATION.
- AREAS TO BE FILLED ARE TO BE CLEARED, GRUBBED, AND STRIPPED OF TOPSOIL TO REMOVE TREES, VEGETATION, ROOTS AND OTHER OBJECTIONABLE MATERIAL.
- 6. CLEARING, GRUBBING, AND TOPSOIL STRIPPING SHALL BE LIMITED TO THOSE AREAS DESCRIBED IN EACH STAGE OF THE CONSTRUCTION SEQUENCE. GENERAL SITE CLEARING, GRUBBING AND TOPSOIL STRIPPING MAY NOT COMMENCE IN ANY STAGE OR PHASE OF THE PROJECT UNTIL THE E&S BMPS SPECIFIED BY THE BMP SEQUENCE FOR THAT STAGE OR PHASE HAVE BEEN INSTALLED AND ARE FUNCTIONING AS DESCRIBED IN 31. AFTER FINAL SITE STABILIZATION HAS BEEN ACHIEVED, TEMPORARY EROSION AND THIS E&S PLAN.
- AT NO TIME SHALL CONSTRUCTION VEHICLES BE ALLOWED TO ENTER AREAS OUTSIDE THE LIMIT OF DISTURBANCE BOUNDARIES SHOWN ON THE PLAN MAPS. THESE AREAS MUST BE CLEARLY MARKED AND FENCED OFF BEFORE CLEARING AND GRUBBING OPERATIONS BEGIN.
- TOPSOIL REQUIRED FOR THE ESTABLISHMENT OF VEGETATION SHALL BE STOCKPILED AT THE LOCATION(S) SHOWN ON THE PLAN MAP(S) IN THE AMOUNT NECESSARY TO COMPLETE THE FINISH GRADING OF ALL EXPOSED AREAS THAT ARE TO BE STABILIZED BY VEGETATION. EACH STOCKPILE SHALL BE PROTECTED IN THE MANNER SHOWN ON THE 33. FAILURE TO CORRECTLY INSTALL E&S BMPS, FAILURE TO PREVENT SEDIMENT-LADEN PLAN DRAWINGS. STOCKPILE HEIGHTS SHALL NOT EXCEED 35 FEET. STOCKPILE SLOPES
- 9. IMMEDIATELY UPON DISCOVERING UNFORESEEN CIRCUMSTANCES POSING THE POTENTIAL FOR ACCELERATED EROSION AND/OR SEDIMENT POLLUTION, THE OPERATOR SHALL IMPLEMENT APPROPRIATE BEST MANAGEMENT PRACTICES TO MINIMIZE THE POTENTIAL FOR EROSION AND SEDIMENT POLLUTION AND NOTIFY THE LOCAL CONSERVATION DISTRICT AND/OR THE REGIONAL OFFICE OF THE DEPARTMENT.
- 10. ALL BUILDING MATERIALS AND WASTES SHALL BE REMOVED FROM THE SITE AND RECYCLED OR DISPOSED OF IN ACCORDANCE WITH THE DEPARTMENT'S SOLID WASTE MANAGEMENT REGULATIONS AT 25 PA. CODE 260.1 ET. SEQ., 271.1, AND 287.1 ET. SEQ. NO BURIED, DUMPED, OR DISCHARGED AT THE SITE.
- 11. ALL OFF-SITE WASTE AND BORROW AREAS MUST HAVE AN E&S PLAN APPROVED BY THE LOCAL CONSERVATION DISTRICT OR THE DEPARTMENT FULLY IMPLEMENTED PRIOR TO 36. UNDERGROUND UTILITIES CUTTING THROUGH ANY ACTIVE CHANNEL SHALL BE
- 12. THE CONTRACTOR IS RESPONSIBLE FOR ENSURING THAT ANY MATERIAL BROUGHT ON SITE IS CLEAN FILL. FORM FP-001 MUST BE RETAINED BY THE PROPERTY OWNER FOR ANY FILL MATERIAL AFFECTED BY A SPILL OR RELEASE OF A REGULATED SUBSTANCE BUT QUALIFYING AS CLEAN FILL DUE TO ANALYTICAL TESTING.
- ALL PUMPING OF WATER FROM ANY WORK AREA SHALL BE DONE ACCORDING TO THE PROCEDURE DESCRIBED IN THIS PLAN, OVER UNDISTURBED VEGETATED AREAS.
- 14. VEHICLES AND EQUIPMENT MAY ENTER DIRECTLY ONTO THE ON-SITE ACCESS ROAD..
- 15. UNTIL THE SITE IS STABILIZED, ALL EROSION AND SEDIMENT BMPS SHALL BE MAINTAINED PROPERLY. MAINTENANCE SHALL INCLUDE INSPECTIONS OF ALL EROSION AND SEDIMENT 39. SEDIMENT BASINS SHALL BE PROTECTED FROM UNAUTHORIZED ACTS BY THIRD PARTIES. BMPS AFTER EACH RUNOFF EVENT AND ON A WEEKLY BASIS. ALL PREVENTATIVE AND REMEDIAL MAINTENANCE WORK, INCLUDING CLEAN OUT, REPAIR, REPLACEMENT, REGRADING, RESEEDING, REMULCHING AND RENETTING MUST BE PERFORMED IMMEDIATELY. IF THE E&S BMPS FAIL TO PERFORM AS EXPECTED, REPLACEMENT BMPS, OR MODIFICATIONS OF THOSE INSTALLED WILL BE REQUIRED.
- 16. A LOG SHOWING DATES THAT E&S BMPS WERE INSPECTED AS WELL AS ANY DEFICIENCIES FOUND AND THE DATE THEY WERE CORRECTED SHALL BE MAINTAINED ON THE SITE AND BE MADE AVAILABLE TO REGULATORY AGENCY OFFICIALS AT THE TIME OF INSPECTION. INSPECTIONS SHALL BE LOGGED ON THE MOST CURRENT DEP FORM 3150-FM-BWEW0083 AND KEPT ON SITE AT ALL TIMES.
- 17. SEDIMENT TRACKED ONTO ANY PUBLIC ROADWAY OR SIDEWALK SHALL BE RETURNED TO THE CONSTRUCTION SITE BY THE END OF EACH WORK DAY AND DISPOSED OF IN THE MANNER DESCRIBED IN THIS PLAN. IN NO CASE SHALL THE SEDIMENT BE WASHED, SHOVELED, OR SWEPT INTO ANY ROADSIDE DITCH, STORM SEWER, OR SURFACE WATER.
- 18. ALL SEDIMENT REMOVED FROM BMPS SHALL BE DISPOSED OF IN THE MANNER DESCRIBED ON THE PLAN DRAWINGS.
- 19. AREAS WHICH ARE TO BE TOPSOILED SHALL BE SCARIFIED TO A MINIMUM DEPTH OF 3 TO 45. MINE OPENINGS ARE NOT ANTICIPATED. IF MINE SPOILS ARE ENCOUNTERED DURING 5 INCHES - 6 TO 12 INCHES ON COMPACTED SOILS - PRIOR TO PLACEMENT OF TOPSOIL. AREAS TO BE VEGETATED SHALL HAVE A MINIMUM 4 INCHES OF TOPSOIL IN PLACE PRIOR TO SEEDING AND MULCHING. FILL OUTSLOPES SHALL HAVE A MINIMUM 2 INCHES OF
- 20. ALL FILLS SHALL BE COMPACTED AS REQUIRED TO REDUCE EROSION, SLIPPAGE, SETTLEMENT, SUBSIDENCE OR OTHER RELATED PROBLEMS. FILL INTENDED TO SUPPORT BUILDINGS, STRUCTURES AND CONDUITS, ETC. SHALL BE COMPACTED IN ACCORDANCE 47. NO WATER RESOURCES EXIST WITHIN THE PROJECT BOUNDARY. WITH LOCAL REQUIREMENTS OR CODES.
- 21. ALL EARTHEN FILLS SHALL BE PLACED IN COMPACTED LAYERS NOT TO EXCEED 9 INCHES
- 22. FILL MATERIALS SHALL BE FREE OF FROZEN PARTICLES, BRUSH, ROOTS, SOD, OR OTHER FOREIGN OR OBJECTIONABLE MATERIALS THAT WOULD INTERFERE WITH OR PREVENT CONSTRUCTION OF SATISFACTORY FILLS.
- 23. FROZEN MATERIALS OR SOFT, MUCKY, OR HIGHLY COMPRESSIBLE MATERIALS SHALL NOT BE INCORPORATED INTO FILLS.
- 24. FILL SHALL NOT BE PLACED ON SATURATED OR FROZEN SURFACES.

#### 1. ALL EARTH DISTURBANCES, INCLUDING CLEARING AND GRUBBING AS WELL AS CUTS AND 25. SEEPS OR SPRINGS ENCOUNTERED DURING CONSTRUCTION SHALL BE HANDLED IN ACCORDANCE WITH THE STANDARD AND SPECIFICATIONS FOR SUBSURFACE DRAIN OR

- BE NOTIFIED OF ANY CHANGES TO THE APPROVED PLAN PRIOR TO IMPLEMENTATION OF 26. ALL GRADED AREAS SHALL BE PERMANENTLY STABILIZED IMMEDIATELY UPON REACHING FINISHED GRADE. CUT SLOPES IN COMPETENT BEDROCK AND ROCK FILLS NEED NOT BE VEGETATED. SEEDED AREAS WITHIN 50 FEET OF A SURFACE WATER, OR AS OTHERWISE SHOWN ON THE PLAN DRAWINGS, SHALL BE BLANKETED ACCORDING TO THE STANDARDS OF THIS PLAN.
  - 27. IMMEDIATELY AFTER EARTH DISTURBANCE ACTIVITIES CEASE IN ANY AREA OR SUBAREA OF A PROJECT, THE OPERATOR SHALL STABILIZE ALL DISTURBED AREAS. DURING NON-GERMINATEING MONTHS, MULCH OR PROTECTIVE BLANKETING SHALL BE APPLIED AS DESCRIBED IN THE PLAN. AREAS NOT AT FINISHED GRADE. WHICH WILL BE REACTIVATED WITHIN 1 YEAR. MAY BE STABILIZED IN ACCORDANCE WITH THE TEMPORARY STABILIZATION SPECIFICATIONS. THOSE AREAS WHICH WILL NOT BE REACTIVATED WITHIN 1 YEAR SHALL BE STABILIZED IN ACCORDANCE WITH THE PERMANENT STABILIZATION SPECIFICATIONS.
  - 28. PERMANENT STABILIZATION IS DEFINED AS A MINIMUM UNIFORM, PERENNIAL 70% VEGETATIVE COVER OR OTHER PERMANENT NON-VEGETATIVE COVER WITH A DENSITY SUFFICIENT TO RESIST ACCELERATED EROSION. CUT AND FILL SLOPES SHALL BE CAPABLE OF RESISTING FAILURE DUE TO SLUMPING, SLIDING, OR OTHER MOVEMENTS.
  - 29. E&S BMPS SHALL REMAIN FUNCTIONAL AS SUCH UNTIL ALL AREAS TRIBUTARY TO THEM ARE PERMANENTLY STABILIZED OR UNTIL THEY ARE REPLACED BY ANOTHER BMP APPROVED BY THE LOCAL CONSERVATION DISTRICT OR THE DEPARTMENT.
  - 30. UPON COMPLETION OF ALL EARTH DISTURBANCE ACTIVITIES AND PERMANENT STABILIZATION OF ALL DISTURBED AREAS, THE OWNER AND/OR OPERATOR SHALL CONTACT THE LOCAL CONSERVATION DISTRICT FOR AN INSPECTION PRIOR TO REMOVAL CONVERSION OF THE E&S BMPS.
  - SEDIMENT BMPS MUST BE REMOVED OR CONVERTED TO PERMANENT POST CONSTRUCTION STORMWATER MANAGEMENT BMPS. AREAS DISTURBED DURING REMOVAL OR CONVERSION OF THE BMPS SHALL BE STABILIZED IMMEDIATELY. IN ORDER TO ENSURE RAPID REVEGETATION OF DISTURBED AREAS, SUCH REMOVAL/CONVERSIONS ARE TO BE DONE ONLY DURING THE GERMINATING SEASON.
  - 32. UPON COMPLETION OF ALL EARTH DISTURBANCE ACTIVITIES AND PERMANENT STABILIZATION OF ALL DISTURBED AREAS, THE OWNER AND/OR OPERATOR SHALL CONTACT THE LOCAL CONSERVATION DISTRICT TO SCHEDULE A FINAL INSPECTION.
  - RUNOFF FROM LEAVING THE CONSTRUCTION SITE, OR FAILURE TO TAKE IMMEDIATE CORRECTIVE ACTION TO RESOLVE FAILURE OF E&S BMPS MAY RESULT IN ADMINISTRATIVE, CIVIL, AND/OR CRIMINAL PENALTIES BEING INSTITUTED BY THE DEPARTMENT AS DEFINED IN SECTION 602 OF THE PENNSYLVANIA CLEAN STREAMS LAW. THE CLEAN STREAMS LAW PROVIDES PROVIDES FOR UP TO \$10,000 PER DAY IN CIVIL PENALTIES, UP TO \$10,000 IN SUMMARY CRIMINAL PENALTIES, AND UP TO \$25,000 IN MISDEMEANOR CRIMINAL PENALTIES FOR EACH VIOLATION.
  - 34. CONCRETE WASH WATER SHALL BE HANDLED IN THE MANNER DESCRIBED ON THE PLAN DRAWINGS. IN NO CASE SHALL IT BE ALLOWED TO ENTER ANY SURFACE WATERS OR GROUNDWATER SYSTEMS.
- BUILDING MATERIALS OR WASTES OR UNUSED BUILDING MATERIALS SHALL BE BURNED, 35. ALL CHANNELS SHALL BE KEPT FREE OF OBSTRUCTIONS INCLUDING BUT NOT LIMITED TO FILL, ROCKS, LEAVES, WOODY DEBRIS, ACCUMULATED SEDIMENT, EXCESS VEGETATION,
  - IMMEDIATELY BACKFILLED AND THE CHANNEL RESTORED TO ITS ORIGINAL CROSS-SECTION AND PROTECTIVE LINING. ANY BASE FLOW WITHIN THE CHANNEL SHALL BE CONVEYED PAST THE WORK AREA IN THE MANNER DESCRIBED IN THIS PLAN UNTIL SUCH RESTORATION IS COMPLETE.
  - 37. CHANNELS HAVING RIPRAP, RENO MATTRESS, OR GABION LININGS MUST BE SUFFICIENTLY OVER-EXCAVATED SO THAT THE DESIGN DIMENSIONS WILL BE PROVIDED AFTER PLACEMENT OF THE PROTECTIVE LINING.
  - 38. SEDIMENT BASINS AND/OR TRAPS SHALL BE KEPT FREE OF ALL CONSTRUCTION WASTE, WASH WATER, AND OTHER DEBRIS HAVING POTENTIAL TO CLOG THE BASIN-TRAP OUTLET STRUCTURES AND/OR POLLUTE THE SURFACE WATERS.

  - 40. ANY DAMAGE THAT OCCURS IN WHOLE OR IN PART AS A RESULT OF BASIN OR TRAP DISCHARGE SHALL BE IMMEDIATELY REPAIRED BY THE PERMITTEE IN A PERMANENT MANNER SATISFACTORY TO THE MUNICIPALITY, LOCAL CONSERVATION DISTRICT, AND THE OWNER OF THE DAMAGED PROPERTY.
  - 41. UPON REQUEST, THE APPLICANT OR HIS CONTRACTOR SHALL PROVIDE AN AS-BUILT (RECORD DRAWING) FOR ANY SEDIMENT BASIN OR TRAP TO THE MUNICIPAL INSPECTOR, LOCAL CONSERVATION DISTRICT OR THE DEPARTMENT.
  - 42. EROSION CONTROL BLANKETING SHALL BE INSTALLED ON ALL SLOPES 3H:1V OR STEEPER WITHIN 50 FEET OF A SURFACE WATER AND ON ALL OTHER DISTURBED AREAS SPECIFIED ON THE PLAN MAPS AND/OR DETAIL SHEETS.
  - 43. FILL MATERIAL FOR EMBANKMENTS SHALL BE FREE OF ROOTS, OR OTHER WOODY VEGETATION, ORGANIC MATERIAL, LARGE STONES, AND OTHER OBJECTIONABLE
  - 44. NO WETLANDS EXIST WITHIN THE PROJECT BOUNDARY.
  - CONSTRUCTION, THE CONTRACTOR SHALL EITHER REWORK THE MATERIAL PER GEOTECHNICAL ENGINEERS RECOMMENDATIONS OR REMOVE THE MATERIAL TO A PERMITTED AREA.
  - 46. NO SIGNIFICANT CULTURAL OR SENSITIVE ENVIRONEMENTAL FEATURES EXIST WITHIN THE PROJECT BOUNDARY. NO FURTHER ENVIRONMENTAL STUDIES WILL BE NECESSARY.

### TEMPORARY STABILIZATION

**SPECIES: ANNUAL RYEGRASS** % PURE LIVE SEED: 98% **APPLICATION RATE: 50 LBS/ACRE** FERTILIZER TYPE: COMMERCIAL FERTILIZER 10-20-20 FERTILIZER APPL. RATE: 678 LBS/ACRE LIMING RATE: 2 TONS/ACRE **MULCH TYPE: HAY & STRAW MULCHING RATE: 3 TONS/ACRE** 

#### **EROSION AND SEDIMENT CONTROL FACILITIES MAINTENANCE SCHEDULE**

1. ALL EROSION AND SEDIMENT CONTROLS SHALL BE MAINTAINED UNTIL A UNIFORM 70% PERENNIAL VEGETATIVE COVER IS ESTABLISHED.

#### **ROCK CONSTRUCTION ENTRANCE**

- 1. THE ROCK CONSTRUCTION ENTRANCES ARE TO BE INSPECTED AT THE END OF EACH WORKING DAY AND REPAIRED IMMEDIATELY.
- 2. THE THICKNESS OF THE ROCK CONSTRUCTION ENTRANCE SHALL BE CONSTANTLY MAINTAINED AT 8".
- 3. A ROCK STOCKPILE IS TO BE READILY AVAILABLE ON THE SITE AT ALL TIMES FOR IMMEDIATE

#### COMPOST FILTER SOCK

- THE COMPOST FILTER SOCK CONTROLS SHALL BE INSPECTED WEEKLY AND AFTER EACH STORM (RUNOFF) EVENT AND REPAIRED IMMEDIATELY.
- 2. ACCUMULATED SEDIMENT SHALL BE REMOVED WHEN DEPOSITS REACH 1/2 THE ABOVE GROUND HEIGHT OF THE SOCK.
- SILT DEPOSITS SHALL BE TAKEN TO THE TOPSOIL STOCKPILE AREA. THE SILT SHALL THEN BE SPREAD OVER STOCKPILE, SEEDED AND MULCHED. 4. ALL UNDERCUTTING OR EROSION OF THE COMPOST FILTER SOCK TOE ANCHOR SHALL BE
- REPAIRED IMMEDIATELY. 5. ANY COMPOST FILTER SOCK SECTION WHICH HAS BEEN UNDERMINED OR TOPPED SHALL BE IMMEDIATELY REPLACED WITH A ROCK FILTER OUTLET.

#### VEGETATION

- 1. THE CONTRACTOR SHALL INSPECT VEGETATED AREAS WEEKLY AND AFTER EACH STORM
- 2. THE CONTRACTOR SHALL INSPECT THE SITE FOR RILLS OR GULLIES ON CUT OR FILL SLOPES. THE CONTRACTOR SHALL FILL RILLS AND GULLIES, REGRADE DISTURBED AREAS TO PROVIDE A UNIFORM SLOPE, THEN RESEED/MULCH AND REPAIR/REPLACE MATS TO ORIGINAL
- 3. THE REPAIRS SHALL BE MADE WITHIN 2 DAYS OF DISCOVERING PROBLEM.

#### PUMPED WATER FILTERING DEVICE

- 1. THE CONTRACTOR SHALL INSPECT FILTER BAGS DAILY AND AFTER EACH STORM (RUNOFF)
- EVENT TO ENSURE THEY ARE WORKING PROPERLY. 2. IF ANY PROBLEM IS DETECTED, PUMPING SHALL CEASE IMMEDIATELY AND NOT RESUME UNTIL
- THE PROBLEM IS CORRECTED. 3. ALL SEDIMENT REMOVED FROM THE FILTER BAGS SHALL BE TAKEN TO THE TOPSOIL STOCKPILE, SPREAD, SEEDED AND MULCHED.

#### RIPRAP OUTLETS

(TEMPORARY AND PERMANENT)

1. INSPECT RIPRAP AFTER HEAVY STORMS AND HIGH FLOWS FOR SCOURING UNDER THE OUTLET AND DISLODGED STONES, AND REPPAIR DAMAGE.

#### SITE STABILIZATION INSTALLATION AND MAINTENANCE

- 1. TILL SOIL TO DEPTH OF 2". REMOVE ALL OBJECTS 2" OR LARGER.
- 2. BLEND COMMERCIAL FERTILIZER INTO THE SOIL TO A DEPTH OF 2". FERTILIZER MAY BE BLENDED DURING TILLING.
- 3. SOW REQUIRED SEED MIXTURE UNIFORMLY ON THE PREPARED AREA BY HYDRAULIC SEEDING EQUIPMENT, HAND SEEDING, OR ANY OTHER APPROPRIATE METHOD.
- 4. AFTER SEEDING ROLL TOPSOILED AREAS THAT ARE TO BE MOWED. USE A ROLLER WEIGHING NOT MORE THAN 65 LBS./FT. WIDTH.
- 5. FOR PERMANENT SITE STABILIZATION APPLY SLOW RELEASE NITROGEN FERTILIZER TO THE 6. PLACE MULCH IMMEDIATELY AFTER SEEDING OR WITHIN 48 HOURS AFTER SEEDING IS

COMPLETED. PLACE HAY & STRAW UNIFORMLY, IN A CONTINUOUS BLANKET AT THE MINIMUM

SEEDING AND SOIL SUPPLEMENT WORK ON A SLOPE HAS BEEN SATISFACTORILY COMPLETED.

RESISTING EROSION DURING RUNOFF EVENTS. THE STANDARD FOR THIS VEGETATIVE COVER

- RATE SPECIFIED ABOVE. AN ACCEPTABLE MECHANICAL BLOWER MAY BE USED TO APPLY MULCH. MACHINES WHICH CUT MULCH INTO SHORT PIECES WILL NOT BE PERMITTED. 8. MAINTENANCE - SATISFACTORILY MAINTAIN GRASS AREAS WITHIN GRADING LIMITS, UNTIL THE ENTIRE PROJECT HAS BEEN COMPLETED. MOW, AS INDICATED AND WHEN DIRECTED. CONTROL PROHIBITED AND NOXIOUS WEED GROWTH BY HERBICIDE SPRAYING OR CUTTING. AFTER THE
- ESTABLISHMENT OF A NEW SLOPE, REAPPLY SOIL SUPPLEMENTS, THEN RESEED, AS SPECIFIED FOR THE ORIGINAL TREATMENT. 9. A SITE WILL BE CONSIDERED TO BE PERMANENTLY STABILIZED WHEN ALL PERMANENT CONTROL MEASURES AND FACILITIES HAVE BEEN COMPLETED AND ARE OPERATIONAL, TEMPORARY CONTROL MEASURES AND FACILITIES REMOVED, AND UNIFORM 70% PERENNIAL VEGETATION COVER IS ESTABLISHED TO THE POINT WHERE THE SURFACE SOIL IS CAPABLE OF

IF A SLOPE FAILURE OCCURS, ONE WHICH REQUIRES REDRESSING, EXCAVATION, OR

WILL BE A UNIFORM COVERAGE OR DENSITY OF 70% ACROSS THE DISTURBED AREA. 10. THE CONTRACTOR SHALL MAINTAIN THE SITE PER THE PROVISIONS OF THIS PLAN UNTIL

## PERMANENT STABILIZATION IS ESTABLISHED.

- **GENERAL NOTES:** THE GENERAL CONTRACTOR SHALL NOTIFY ALL UTILITY COMPANIES INVOLVED IN THE SITE NO MORE THAN TEN DAYS AND NO LESS THAN THREE DAYS IN ADVANCE OF EXCAVATION (PA ACT 287 OF 1974 AMENDED BY ACT 121 OF 2008).
- 2. TRAFFIC SHALL BE MAINTAINED ON ALL ADJOINING STREETS AND DRIVES AT ALL TIMES. TRAFFIC CONTROL SHALL BE MAINTAINED IN ACCORDANCE WITH PENNDOT'S REQUIREMENTS.
- 3. CONTRACTOR SHALL USE ASPHALT WEDGE CURBS, UNLESS NOTED, OUTSIDE OF THE PUBLIC
- 4. CONTRACTOR SHALL VERIFY THE LOCATION AND INVERT ELEVATION OF ALL EXISTING UTILITIES WITH PROPOSED CONNECTIONS PRIOR TO CONSTRUCTION AND GRADING OF THE
- 5. THE CONTRACTOR SHALL INSTALL ALL PAVEMENT MARKINGS AS SHOWN ON THE PLANS.

AND NECESSARY APPROVALS BY PERMITTING AGENCIES.

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- 1. THE CONTRACTOR SHALL PROOF ROLL THE SITE TO THE SATISFACTION OF THE GEOTECHNICAL ENGINEER AND REMOVE ANY SOFT MATERIAL PRIOR TO THE IMPORTING OF ANY FILL MATERIAL.
- 2. THE CONTRACTOR SHALL COMPACT ALL STRUCTURAL FILLS IN ACCORDANCE WITH THE GEOTECHNICAL ENGINEER'S RECOMMENDATIONS WITHIN THE REPORT PREPARED BY YOUNG & ASSOCIATES. DATED FEBRUARY 2022.
- 3. THE CONTRACTOR SHALL USE PENNDOT'S LATEST REFERENCES OF PUBLICATION 408/2000 AND

CONSENT IS GIVEN BY THE ENGINEER. THE CONTRACTOR AND/OR THE OWNER WILL BE HELD RESPONSIBLE FOR ANY FIELD MODIFICATIONS MADE WITHOUT THE WRITTEN CONSENT OF THE ENGINEER THE LOCATION OF EXISTING UTILITIES WERE TAKEN FROM RECORDS AND MARKING PROVIDED BY OTHERS AND OBSERVED EVIDENCE. THE LOCATIONS SHOWN MAY BE APPROXIMATE. THE CONTRACTOR IS RESPONSIBLE FOR DETERMINING THE EXACT LOCATIONS, SIZES AND DEPTH OF ALL UTILITIES PRIOR TO CONSTRUCTION. THE CONTRACTOR SHALL EXERCISE CARE TO AVOID DAMAGE THE PRINTING UTILITIES. A REGISTERED K \ PROFESSIONAL \ WILLIAM PAUL UTZMAN ENGINEER √\No. PE079163/

SHEET NO.

444444 00000

SCALE:

LEGEND:

s SEEDING & MULCHING

IP INLET PROTECTION


COMPOST FILTER SOCK

RCE ROCK CONSTRUCTION ENTRANCE

CO CONCRETE WASHOUT

SOIL MAP UNIT LEGEND				
MAP UNIT SYMBOL MAP UNIT NAME				
DoB	DORMONT SILT LOAM			
GyB	GUERNSEY SILT LOAM			

Barrier Number	Diameter (in)	Location	Slope Percent	Slope Length Above Barrier (ft)
CFS 1	12	See Sheet C701	1.1	264
CFS 2	12	See Sheet C701	4.8	21
CFS 3	12	See Sheet C701	1.6	62
CFS 4	12	See Sheet C701	1.2	246
CFS 5	12	See Sheet C701	1.4	277
CFS 6	12	See Sheet C701	3.2	310
CFS 7	12	See Sheet C701	0.4	243
CFS 8	12	See Sheet C701	0.8	265
CFS 9	12	See Sheet C701	1.6	256
CFS 12	12	See Sheet C701	2.7	37
CFS 13	12	See Sheet C701	2.7	110
CFS 14	12	See Sheet C701	8.9	45
CFS 15	12	See Sheet C701	8.5	71
CFS 16	12	See Sheet C701	8.5	82
CFS 17	12	See Sheet C701	7.9	101
CFS 18	12	See Sheet C701	6.0	133
CFS 19	12	See Sheet C701	4.9	183
CFS 20	12	See Sheet C701	4.5	243
CFS 21	12	See Sheet C701	3.3	150
CFS 22	12	See Sheet C701	7.1	70

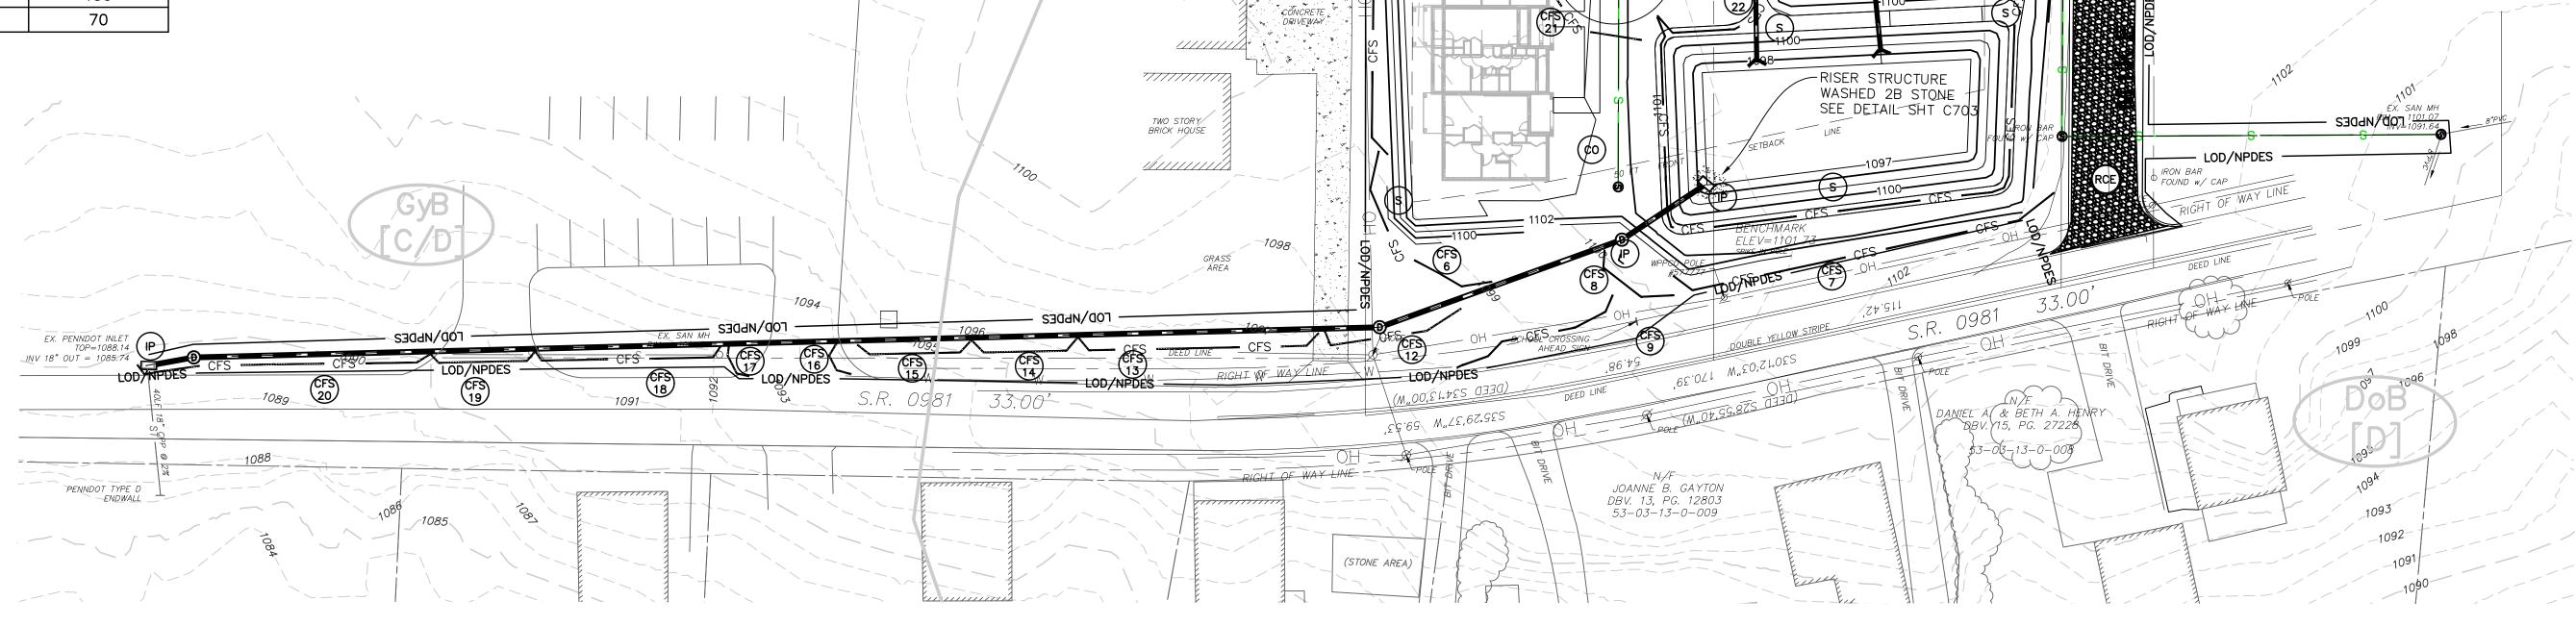

TEMPORARY SOIL STOCKPILE

ONE STORY BRICK (

RIGHT REVEREND J.F. REGIS
CANEVIN IN TRUST FOR USE OF
SLAVISH ROMAN CATHOLIC
CONTROL OF THE PROPERTY OF THE PR

DBV. 477, PG. 453 53-03-13-0-001

TWO STORY BUILDING

ONE STORY BUILDING

ELIZABETH'& JAMES P. TAKITCH DBV. 3203, PG. 300

53-02-00-0-092

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<u>LEGEND</u>

SAN - SANITARY ST - STORM MH - MANHOLE TOP - TOP OF CASTING INV - INVERT / FLOW LINE WV - WATER VALVE GV – GAS VALVE
GM – GAS METER
EM – ELECTRIC METER


RCP - REINFORCED CONCRETE PIPE


CPP - CORRUGATED PLASTIC PIPE

S.R. – STATE ROUTE TELE – TELEPHONE

——G—— – GAS LINE ----T --- SUBSURFACE TELEPHONE LINE ----E --- - SUBSURFACE ELECTRIC LINE -- 908 -- - EXISTING CONTOURS EXISTING INLET EXISTING MANHOLE

—X——X— – FENCE

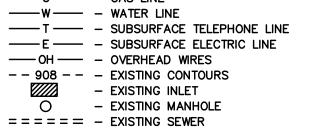

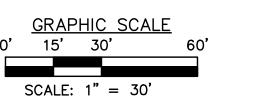

THE ENGINEER ASSUMES NO RESPONSIBILITY FOR ANY CHANGES IN DESIGN PLANS UNLESS WRITTEN CONSENT IS GIVEN BY THE ENGINEER. THE CONTRACTOR AND/OR THE OWNER WILL BE HELD RESPONSIBLE FOR ANY FIELD MODIFICATIONS MADE WITHOUT THE WRITTEN CONSENT OF THE ENGINEER AND NECESSARY APPROVALS BY PERMITTING AGENCIES.

IRON BAR / FOUND w/ CAP

IRON BAR

FOUND W/ CAP

N/F JAMES F. & MARCIA L.

FEARER DBV. 2704, PG. 489 53-03-13-0-004

VIRON BAR FOUND

O IRON BAI

**#######** 

DES REV DR, DA

1" = 30'

SCALE:

Knowles lates, Inc.


Morris & Assoc (A Hammon

CONTROL

RESIDENCES

THE LOCATION OF EXISTING UTILITIES WERE TAKEN FROM RECORDS AND MARKING PROVIDED BY OTHERS AND OBSERVED EVIDENCE. THE LOCATIONS SHOWN MAY BE APPROXIMATE. THE CONTRACTOR IS RESPONSIBLE FOR DETERMINING THE EXACT LOCATIONS, SIZES AND DEPTH OF ALL UTILITIES PRIOR TO CONSTRUCTION. THE CONTRACTOR SHALL EXERCISE CARE TO AVOID DAMAGE TO ALL EXISTING UTILITIES.

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SHEET NO. C701

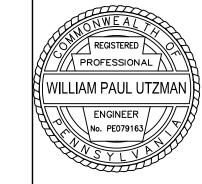SEDIMENTATION AND EROSION CHURCH

2"X2" WOODEN STAKES FILTER SOCK UNDISTURBED PLACED 10' O.C. **PLAN VIEW** 

NOTES:

Sock fabric shall meet standards of Table 4.1. Compost shall meet the standards of Table 4.2.

Compost filter sock shall be placed at existing level grade. Both ends of the sock shall be extended at least 8 feet up slope at 45 degrees to the main sock alignment (Figure 4.1). Maximum slope length above any sock shall not exceed that shown on Figure 4.2. Stakes may be installed immediately downslope of the sock if so specified by the manufacturer.

Traffic shall not be permitted to cross filter socks.

Accumulated sediment shall be removed when it reaches half the aboveground height of the sock and disposed in the manner described elsewhere in the plan.

Socks shall be inspected weekly and after each runoff event. Damaged socks shall be repaired according to manufacturer's specifications or replaced within 24 hours of inspection.

Biodegradable filter socks shall be replaced after 6 months: photodegradable socks after 1 year. Polypropylene socks shall be replaced according to manufacturer's recommendations.

Upon stabilization of the area tributary to the sock, stakes shall be removed. The sock may be

left in place and vegetated or removed. In the latter case, the mesh shall be cut open and the

mulch spread as a soil supplement. STANDARD CONSTRUCTION DETAIL #4-1 <u>COMPOST FILTER SOCK</u>

# TABLE 4.1

COMPOST SOCK FABRIC MINIMUM SPECIFICATIONS


3 MIL HDPE	5 MIL HDPE	5 MIL HDPE	MULTI-FILAMENT POLYPROPYLENE (MFPP)	HEAVY DUTY MULTI-FILAMENT POLYPROPYLENE (HDMFPP)
PHOTO- DEGRADABLE	PHOTO- DEGRADABLE	BIO- DEGRADABLE	PHOTO— DEGRADABLE	PHOTO- DEGRADABLE
12" 18"	12" 18" 24" 32"	12" 18" 24" 32"	12" 18" 24" 32"	12" 18" 24" 32"
3" 8	3" 8	3°°	3" 8	<u>1</u> "
	26 PSI	26 PSI	44 PSI	202 PSI
23% AT 1000 HR	23% AT 1000 HR		100% AT 1000 HR	100% AT 1000 HR
6 MONTHS	9 MONTHS	6 MONTHS	1 YEAR	2 YEARS
	PHOTO— DEGRADABLE 12" 18" 23" 23% AT 1000 HR	PHOTO— DEGRADABLE  12" 12" 18" 24" 32"  3" 3" 8" 26 PSI  23% AT 1000 HR  PHOTO— DEGRADABLE  22" 32" 38" 24" 32" 32" 32" 32" 32" 32" 32" 32" 32" 32	PHOTO— DEGRADABLE  12" 12" 12" 12" 18" 18" 24" 32" 32"  3" 3" 8" 8" 8"  26 PSI 26 PSI  23% AT 1000 HR  PHOTO— DEGRADABLE  BIO— DEGRADABLE  120" 12" 12" 12" 12" 12" 12" 12" 12" 12" 12	PHOTO— DEGRADABLE  PHOTO— DEGRADABLE  12" 18" 18" 18" 18" 18" 24" 32" 32" 32" 32" 32" 38"  26 PSI  23% AT 1000 HR  PHOTO— DEGRADABLE  PHOTO— DEGRADABLE  PHOTO— DEGRADABLE  PHOTO— DEGRADABLE  PHOTO— DEGRADABLE  12" 12" 12" 12" 12" 12" 18" 24" 24" 32" 32" 32" 32" 32" 32" 32" 32" 32" 32

INNER CONTAINMENT NETTING ONTINUOUSLY WOUND SION-WELDED JUNCTURES <u>" X 🖁" MAX. APERTURE SIZE</u> OUTER FILTRATION MESH COOMPOSITE POLYPROPYLENE FABRIC (WOVEN LAYER AND NON-WOVEN FLEECE MECHANICALLY FUSED VIA NEEDLE PUNCH) 话" MAX. APERTURE SIZE


SOCK FABRICS COMPOSED OF BURLAP MAY BE USED ON PROJECTS LASTING 6 MONTHS OR LESS. FILTREXX & JMD

# **COMPOST STANDARDS**

ORGANIC MATTER CONTENT	25% - 100% (DRY WEIGHT BASIS)
ORGANIC PORTION FIBROUS AND ELONGATED	
рН	5.5 - 8.5
MOISTURE CONTENT	30% - 60%
PARTICLE SIZE	30% - 50% PASS THROUGH ₹ SIEVE
SOLUBLE SALT CONCENTRATION	5.0 dS/m (MMHOS/CM) MAXIMUM

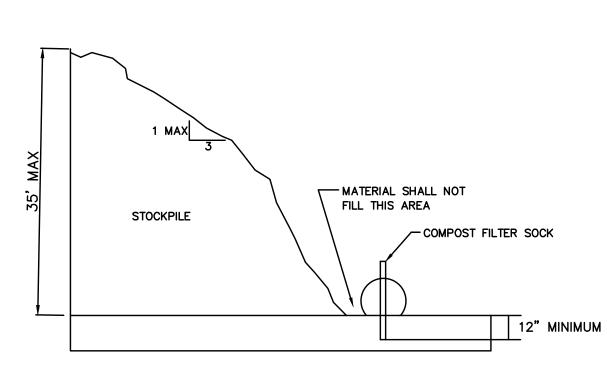

SOIL STOCKPILE DETAIL

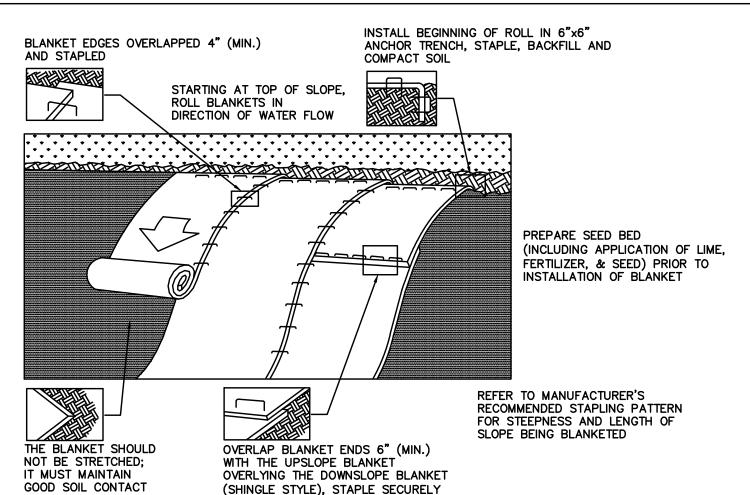

Seed and soil amendments shall be applied according to the rates in the plan drawings prior to installing the blanket.

Provide anchor trench at toe of slope in similar fashion as at top of slope.


Slope surface shall be free of rocks, clods, sticks, and grass.

Blanket shall have good continuous contact with underlying soil throughout entire length. Lay blanket loosely and stake or staple to maintain direct contact with soil. Do not stretch blanket.


The blanket shall be stapled in accordance with the manufacturer's recommendations.


Blanketed areas shall be inspected weekly and after each runoff event until perennial vegetation is established to a minimum uniform 70% coverage throughout the blanketed area. Damaged or displaced blankets shall be restored or replaced within 4 calendar days.

#### STANDARD CONSTRUCTION DETAIL #11-1 **EROSION CONTROL BLANKET INSTALLATION**

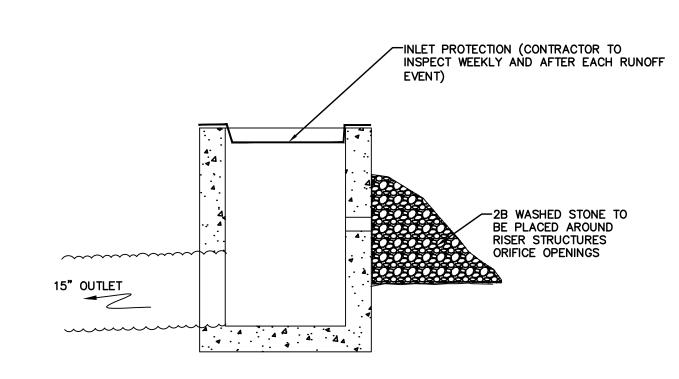

#### FIGURE 3.18 TYPICAL COMPOST SOCK WASHOUT INSTALLATION

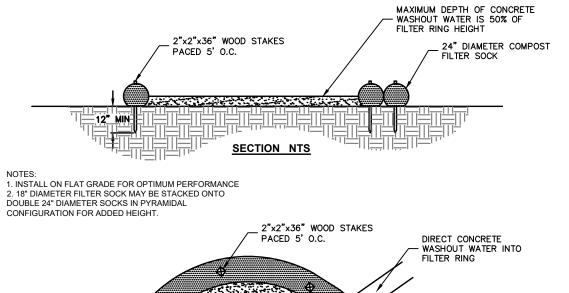

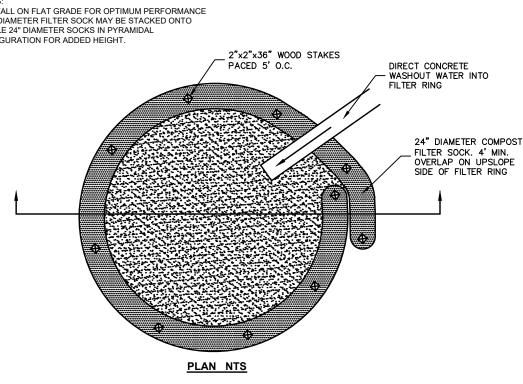

A SUITABLE IMPERIOUS GEOMEMBRANE SHALL BE PLACED AT THE LOCATION OF THE WASHOUT PRIOR TO INSTALLING THE SOCKS. ADAPTED FROM FILTREXX

COMPOST FILTER SOCK CONCRETE WASHOUT

A. LIMIT ADVANCE CLEARING AND GRUBBING OPERATIONS TO A DISTANCE EQUAL TO TWO TIMES THE LENGTH OF PIPE INSTALLATION THAT CAN BE COMPLETED IN ONE DAY.

B. WORK CREWS AND EQUIPMENT FOR TRENCHING, PLACEMENT OF PIPE, PLUG CONSTRUCTION AND BACKFILLING WILL BE SELF CONTAINED AND SEPARATE FROM CLEARING AND GRUBBING AND SITE RESTORATION AND STABILIZATION OPERATIONS.

C. LIMIT DAILY TRENCH EXCAVATION TO THE LENGTH OF PIPE PLACEMENT, PLUG INSTALLATION AND BACKFILLING THAT CAN BE COMPLETED THE SAME DAY.

D. TRENCH PLUGS WILL BE SPACED IN ACCORDANCE WITH THE TABLE BELOW:


TRENCH SLOPE %	LENGTH (FEET)	PLUG MATERIAL
0 - 5		NONE
5 - 15	500	EARTH FILLED SACKS
15 – 25	300	EARTH FILLED SACKS
25 - 35	200	EARTH FILLED SACKS
35 - 100	100	EARTH FILLED SACKS
OVER 100	50	CEMENT FILLED BAGS (WETTED)

WILL REMAIN IN EFFECT WITH THE FOLLOWING EXCEPTIONS:

1. DAILY BACKFILLING OF THE TRENCH MAY BE DELAYED FOR SIX DAYS.

2. IF DAILY BACKFILLING IS DELAYED, THE DISTURBED AREA WILL BE GRADED TO FINAL CONTOURS FOR UTILITIES THAT REQUIRE TESTING BEFORE THE TRENCH IS BACKFILLED, ALL OF THE ABOVE ITEMS APPROPRIATE TEMPORARY EROSION AND SEDIMENT CONTROL MEASURES/FACILITIES WILL BE INSTALLED AND THE AREAS SEEDED AND MULCHED WITHIN THE NEXT TWO DAYS.

#### UTILITY TRENCH EXCAVATING GUIDELINES

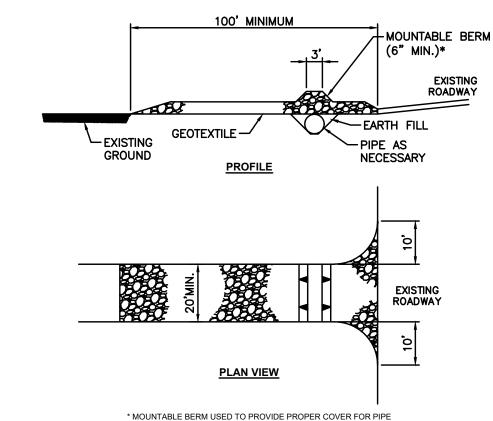

NOTES:


Remove topsoil prior to installation of rock construction entrance. Extend rock over full width of entrance.

Runoff shall be diverted from roadway to a suitable sediment removal bmp prior to entering rock construction entrance.

Mountable berm shall be installed wherever optional culvert pipe is used and proper pip cover as specified manufacturer is not otherwise provided. Pipe shall be sized appropriately for size of ditch being crossed.

MAINTENANCE: Rock Construction Entrance thickness shall be constantly maintained to the specified dimensions by adding rock. A stockpile shall be maintained on site for this purpose. At the end of each construction day, all sediment deposited on paved roadways shall be removed and returned to the construction site immediately. If excessive amounts of sediment are being deposited on roadway, extent length of rock construction entrance by 50 foot increments until condition is alleviated or install wash rack. Washing the roadway or sweeping the deposits into roadway ditches, sewers, culverts, or other drainage courses is


#### STANDARD CONSTRUCTION DETAIL #3-1 **ROCK CONSTRUCTION ENTRANCE** N.T.S.

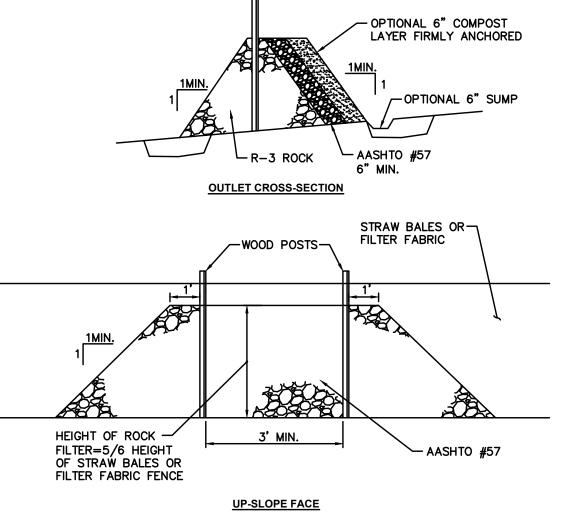

A rock filter outlet shall be installed where failure of a silt fence or straw bale barrier has occurred due to concentrated flow. Anchored compost layer shall be used on upslope face in HQ and EV watersheds.

Sediment shall be removed when accumulations reach 1/3 the height of the outlet.

STANDARD CONSTRUCTION DETAIL #4-6 ROCK FILTER OUTLET

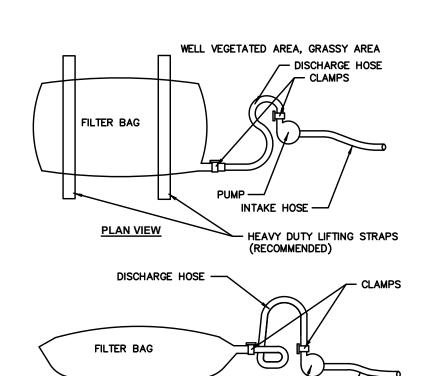

Low volume filter bags shall be made from non-woven geotextile material sewn with high strength, double stitched "J" type seams. They shall be capable trapping particles larger than 150 microns. High volume filter

INTAKE HOSE

b	ags shall be made from wove	en geotextiles that me	eet the following standards
	Property	Test Method	Minimum Standard
	Avg. wide width strenght	ASTM D-4884	60 lb/in
	Grab tensile	ASTM D-4632	250 lb
	Puncture	ASTM D-4833	110 lb
	Mullen burst	ASTM D-3786	350 psi
	UV resistance	ASTM D-4355	70%
	AOS % retained	ASTM D-4751	80 sieve

**ELEVATION VIEW** 

WELL VEGETATED, GRASSY AREA

AOS % retained ASTM D-4751 80 sieve A suitable means of accessing the bag with machinery required for disposal purposes shall be provided. Filter bags shall be replaced when they become 1/2 full of sediment. Spare bags shall be kept available for replacement of those that have failed or are filled. Bags shall be placed on straps to facilitate removal unless bags come with lifting straps already attached.

Bags shall be located in well-vegetated (grassy) area, and discharge onto stable, erosion resistant areas. Where this is not possible, a geotextile underlayment and flow path shall be provided. Bags may be placed on filter stone to increase discharge capacity. Bags shall not be placed on slopes greater than 5%. For slopes exceeding 5%, clean rock or other non-erodible and non-polluting material may be placed under the bag to reduce slope steepness.


No downslope sediment barrier is required for most installations. Compost berm or compost filter sock shall be installed below bags located in HQ or EV watersheds, within 50 feet of any receiving surface water or where grassy area is not available.

The pump discharge hose shall be inserted into the bags in the manner specified by the manufacturer and securely clamped. A piece of PVC pipe is recommended for this purpose. The pumping rate shall be no greater than 750 gpm or 1/2 the maximum specified by the manufacturer,

whichever is less. Pump intakes shall be floating and screened. Filter bags shall be inspected daily. If any problem is detected, pumping shall cease immediately and not

resume until the problem is corrected.

#### STANDARD CONSTRUCTION DETAIL #3-16 PUMPED WATER FILTER BAG N.T.S.

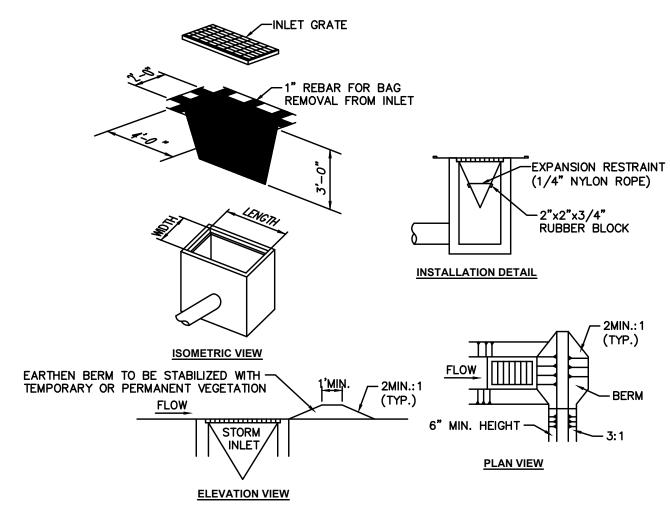

NOTES:

Maximum drainage area = 1/2 acre.

Inlet protection shall not be required for inlet tributary to sediment basin or trap. Berms shall be required for all installations

Rolled earthen berm shall be maintained until roadway is stoned. Road subbase berm shall be maintained until roadway is paved. Earthen berm in channel shall be maintained until permanent stabilization is completed or remain permanently.

At a minimum, the fabric shall have a minimum grab tensile strength of 120 lbs, a minimum burst strength of 200 psi, and a minimum trapezoidal tear strength of 50 lbs. Filter bags shall be capable of trapping all particles not passing a No. 40 Sieve.

Inlet filter bags shall be inspected on a weekly basis and after each runoff event. Bags shall be emptied and rinsed or replaced when half full or when flow capacity has been reduced so as to cause flooding or bypassing of the inlet. Damaged or clogged bags shall be replaced. A supply shall be maintained on site for replacement of bags. All needed repairs shall be initiated immediately after the inspection. Dispose of accumulated sediment as well as all used bags according to the plan notes.


DO NOT USE ON MAJOR PAVED ROADWAYS WHERE PONDING MAY CAUSE TRAFFIC

#### STANDARD CONSTRUCTION DETAIL #4-16 FILTER BAG INLET PROTECTION - TYPE M INLET

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SHEET NO. C702

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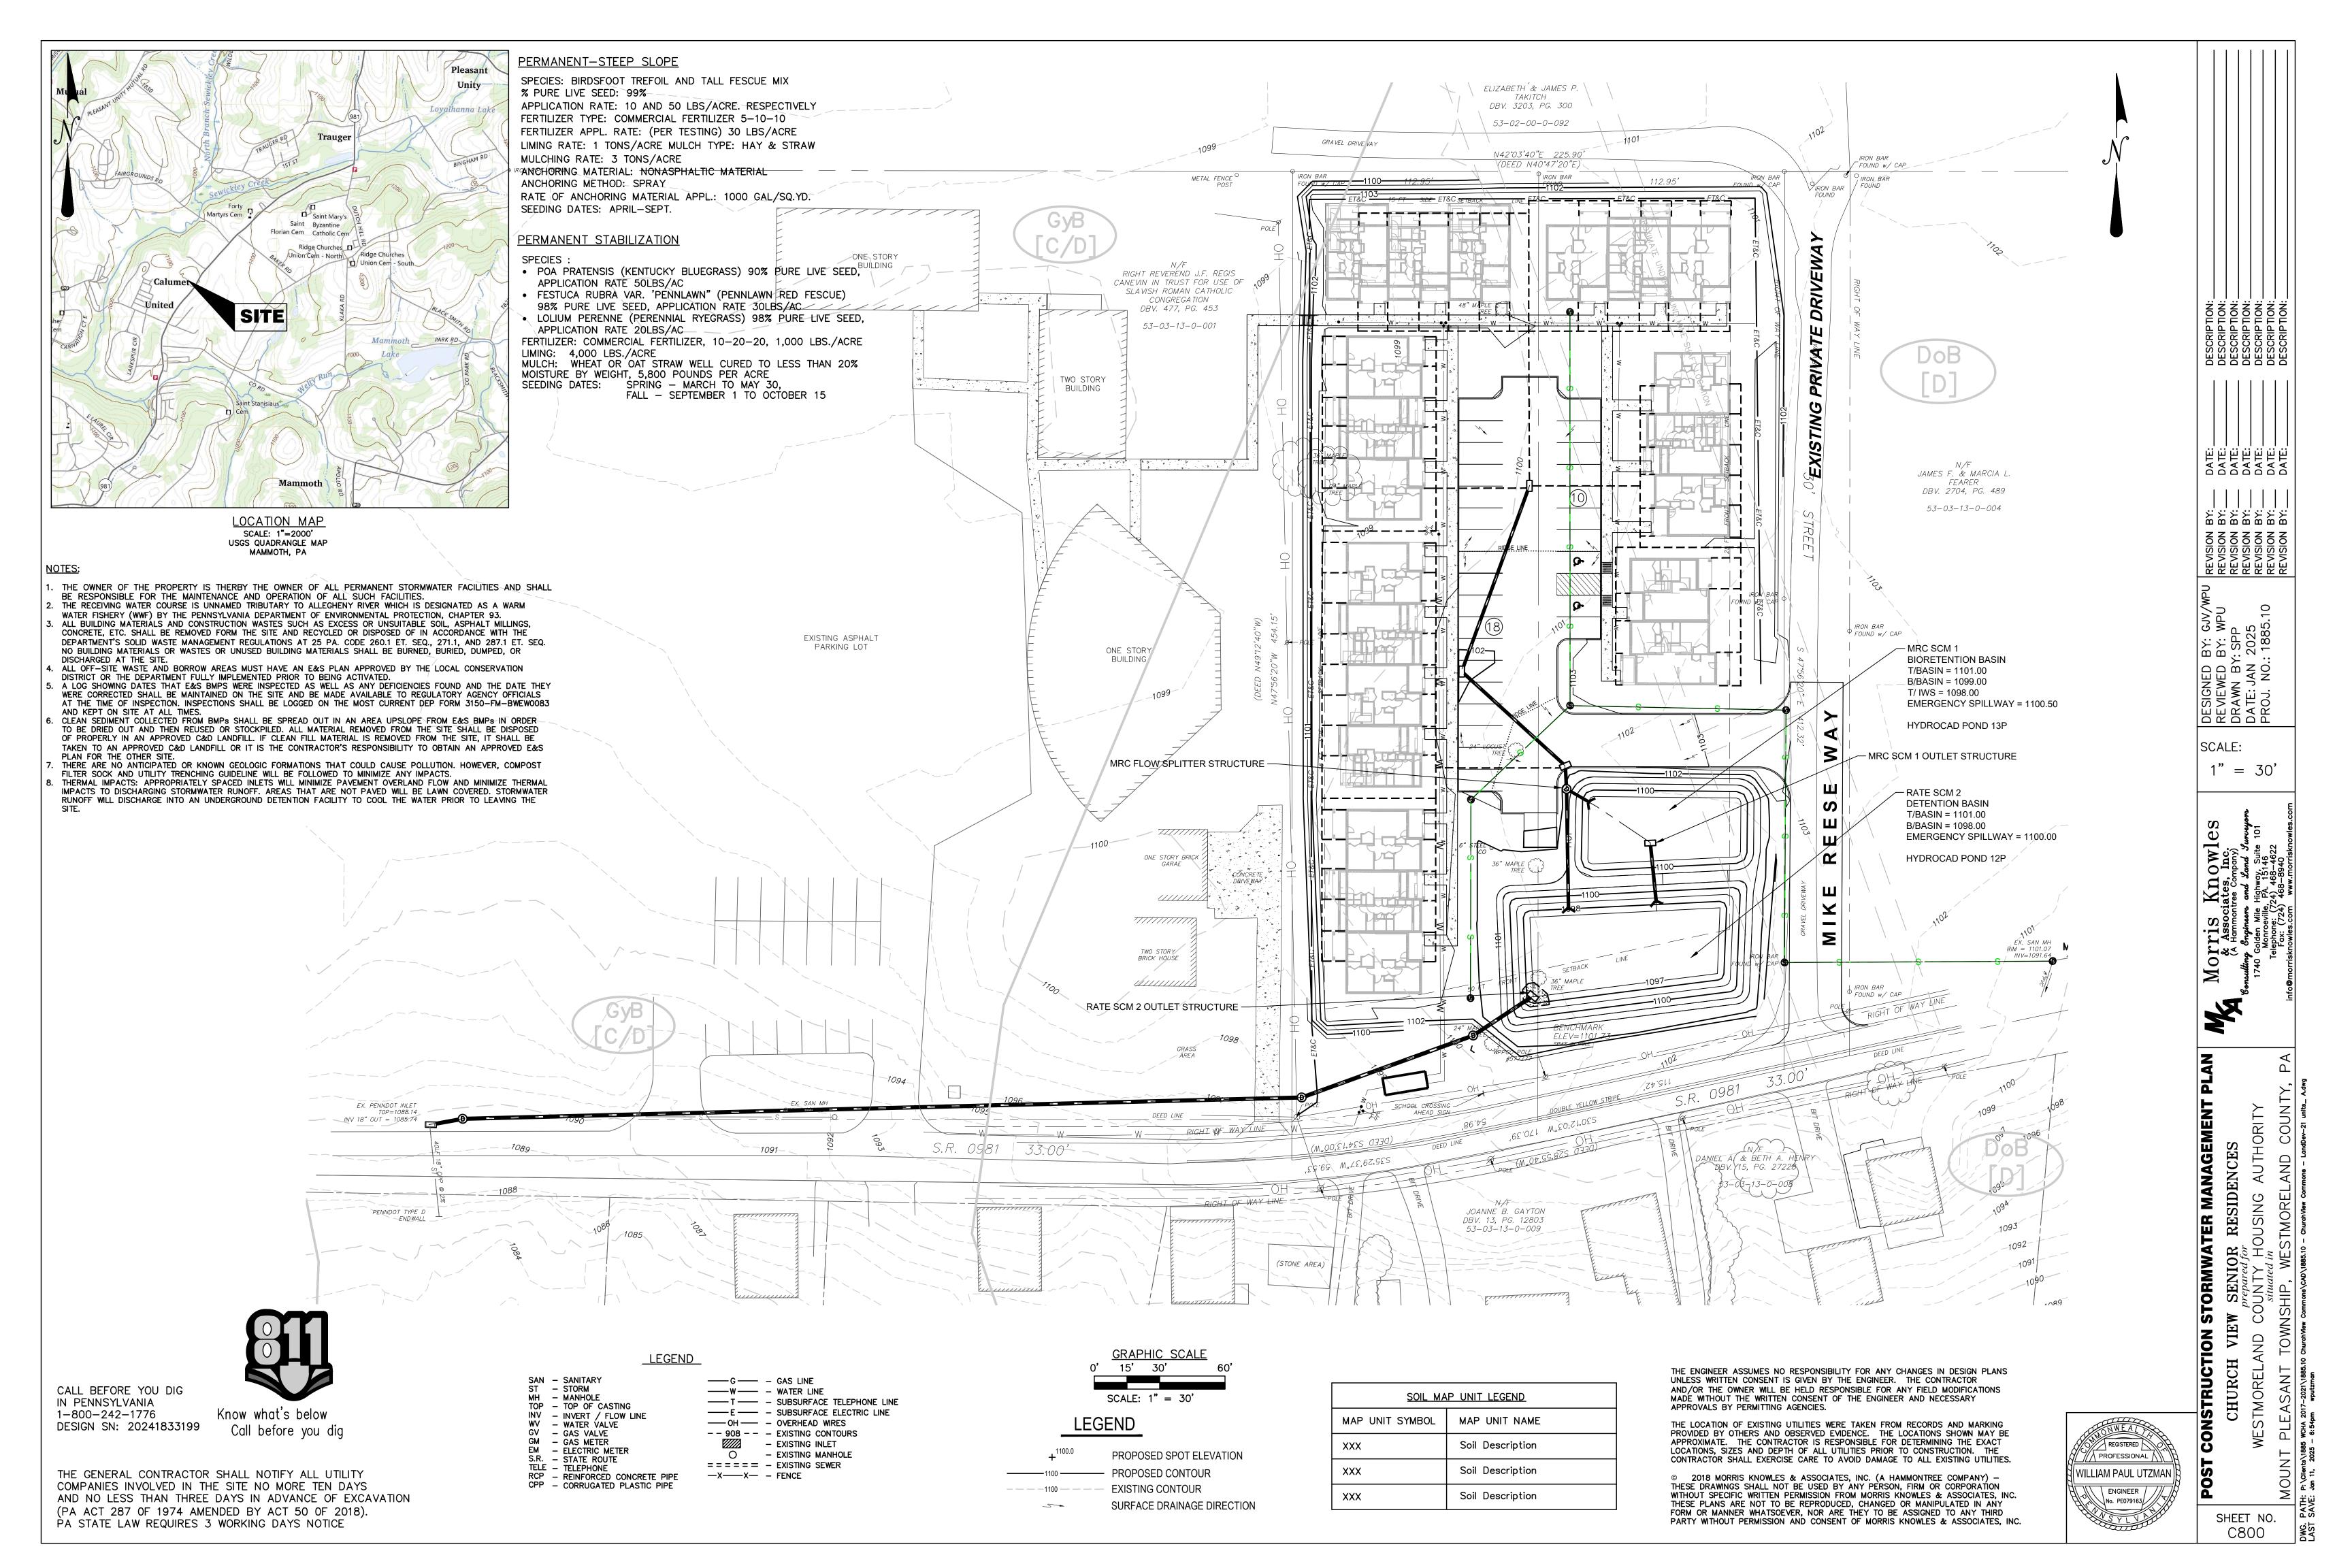
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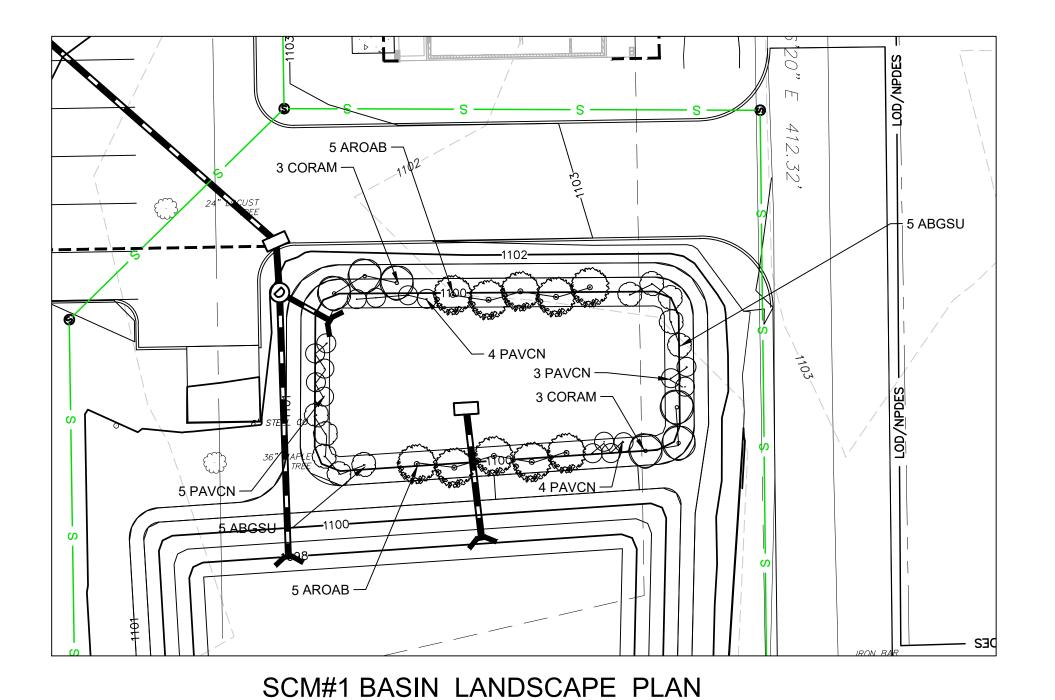
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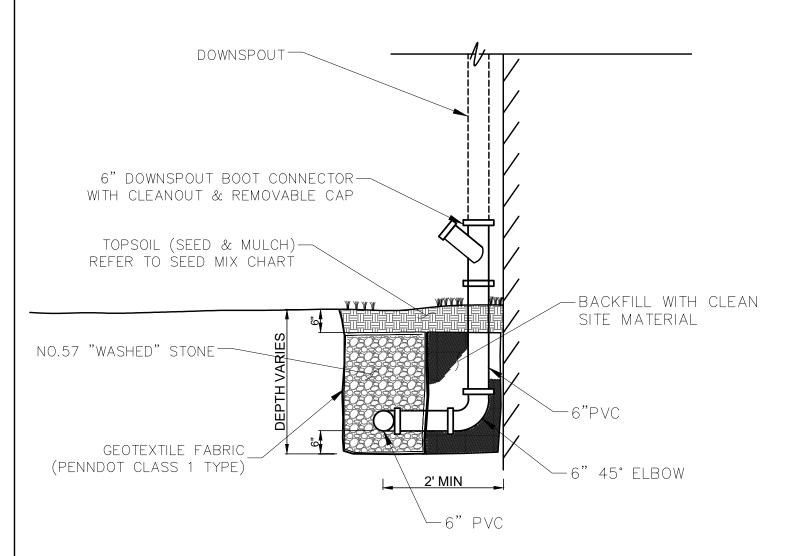
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N.T.S.

				ING SCI			LIFIOLIT
LEGEND	KEY	QTY	BOTANICAL NAME	COMMON NAME	SIZE	REMARKS -	HEIGHT SPRFAI
. }	ABGSU	10	Abelia x grandiflora 'Sunrise'	Sunrise Variegated Abelia	No.1 Cont.	Evergreen White Flwrs	3-5' 4-6'
- Townson	AROAB	10	Aronia arbutifolia 'Brilliantissima'	Brilliant Red Chokeberry	No. 5 Cont.	Deciduous Red Fruit	7'-8' 10'
A STATE OF THE STA			J		1		
	CORAM	6	Cornus amomum	Silky Dogwood	3' Ht. B & B	Deciduous	6-10' 6-10'
	PAVCN	16	Panicum virgatum 'Cloud Nine'	Cloud Nine Switch Grass	No. 1 Cont.	Onr. Grass Arching	68' 5'-6'

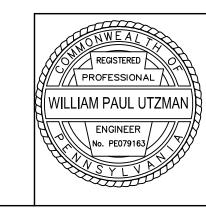


### TYPICAL DOWNSPOUT CONNECTION N.T.S.



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#### **EDIT PER JOB**

#### MAINTENANCE PROGRAM:


DURING CONSTRUCTION, ALL FILTER FABRIC FENCE AND EROSION AND SEDIMENTATION CONTROL FACILITIES WILL BE INSPECTED, AS NEEDED, TO INSURE ALL SYSTEMS ARE FUNCTIONING PROPERLY. FILTER FABRIC FENCE WILL BE REPLACED, AS NEEDED. THE CONTRACTOR WILL BE RESPONSIBLE FOR REPLACEMENT AND

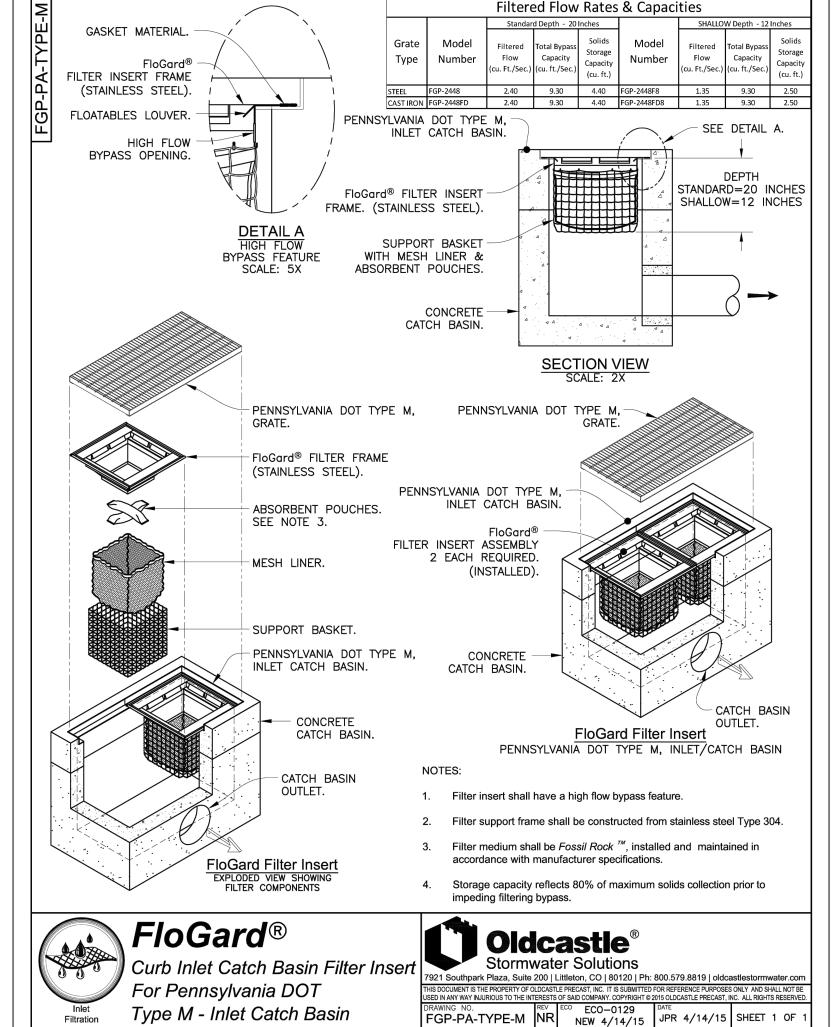DURING CONSTRUCTION, ALL CONSTRUCTION ENTRANCES TO THE SITE WILL BE PROTECTED BY GRAVEL BEDS. THE INFILTRATION SYSTEMS WILL BE INSPECTED PERIODICALLY DURING CONSTRUCTION AND AGAIN UPON PROJECT COMPLETION FOR PROPER OPERATION. THE SYSTEM WILL THEREAFTER BE INSPECTED EACH MONTH BY THE OWNER. IF THE SYSTEM SHOWS ANY SIGNS OF FAILURE OR IMPROPER OPERATION AT ANY TIME, THE OWNER WILL REPLACE AND/OR REPAIR THE AFFECTED AREAS.

INSPECTION OF THE STORMWATER MANAGEMENT SYSTEM WILL INCLUDE:

INSPECTION SHALL BE DONE OF THE ENTIRE STORMWATER MANAGEMENT FACILITY AFTER EVERY STORM EVENT EXCEEDING ONE INCH OF RAINFALL AND AT LEAST ONCE EVERY THREE MONTHS. THIS INSPECTION


- 1. INSPECTION OF INLET BOXES AND STORM SEWERS FOR ACCUMULATIONS OF DEBRIS AND/OR SEDIMENT.
- 2. MAINTENANCE OF THE FACILITIES SHALL INCLUDE VEGETATION CUTTING AND/OR REMOVAL ALONG WITH ROUTINE MAINTENANCE AS DETERMINED BY THE ENGINEER.
- 3. THE OWNER SHALL CONTACT THE ENGINEER IF ANY SIGNS OF FAILURE HAVE BEEN FOUND DURING THE MONTHLY INSPECTION.
- 4. A RECORD OF THE INSPECTIONS SHOULD BE KEPT BY THE OWNER FOR REVIEW BY THE MUNICIPALITY.
- 5. INSPECTION OF THE BIO-RETENTION FACILITY FOR ACCUMULATIONS OF DEBRIS AND/OR SEDIMENT ALONG WITH SIGNS OF FAILURE OR EROSION. IF ACCUMULATIONS OF DEBRIS AND/OR SEDIMENT HAVE OCCURRED, THEN IT IS THE OWNER'S RESPONSIBILITY TO REMOVE THE DEBRIS AND/OR SEDIMENT AND REPAIR THE FACILITY TO PROPER OPERATION.
- a. SEDIMENT REMOVAL SHOULD OCCUR WHEN THE BASIN IS DRY. DISPOSAL OF DEBRIS, TRASH, SEDIMENT AND OTHER WASTE MATERIAL SHOULD BE DISPOSED OF IN COMPLIANCE WITH ALL APPLICABLE LOCAL, STATE, AND FEDERAL WASTE REGULATIONS.
- b. IF THE DRAIN TIME OF THE BIO-RETENTION BASIN EXCEEDS 72 HOURS, THEN THE SYSTEM'S PLANTING SOIL BED AND UNDERDRAIN SYSTEM MUST BE EVALUATED AND APPROPRIATE MEASURES TAKEN TO COMPLY WITH THE MAXIMUM DRAIN TIME REQUIREMENTS AND PROPER FUNCTIONING OF THE SYSTEM.

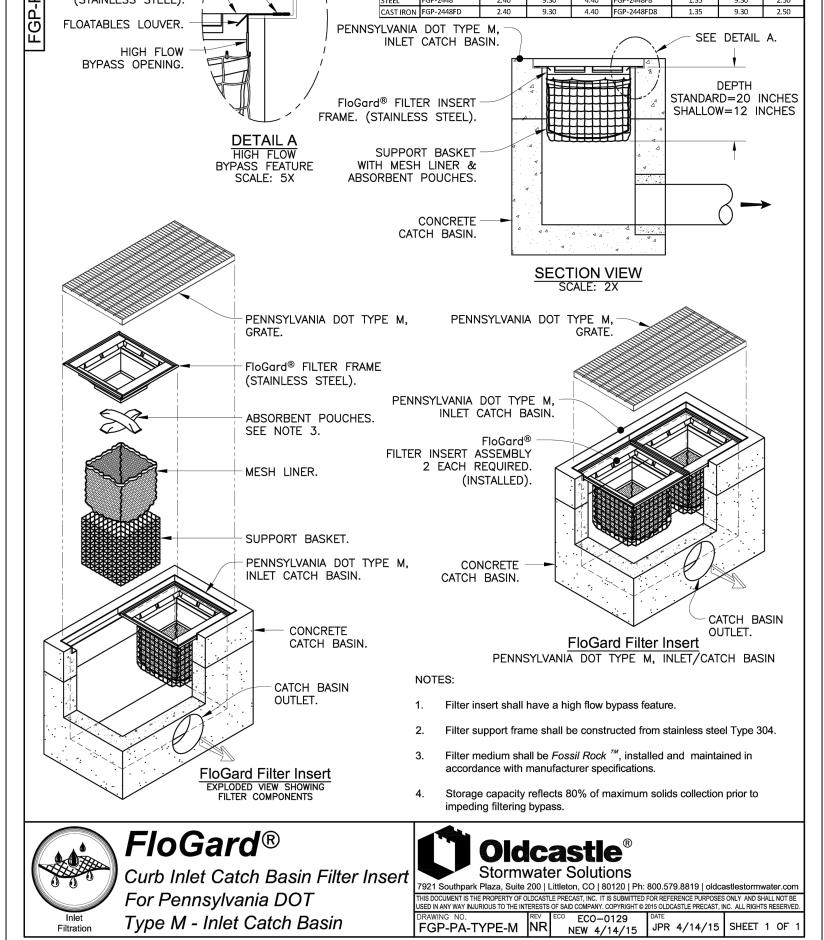

THE ENGINEER ASSUMES NO RESPONSIBILITY FOR ANY CHANGES IN DESIGN PLANS UNLESS WRITTEN CONSENT IS GIVEN BY THE ENGINEER. THE CONTRACTOR AND/OR THE OWNER WILL BE HELD RESPONSIBLE FOR ANY FIELD MODIFICATIONS MADE WITHOUT THE WRITTEN CONSENT OF THE ENGINEER AND NECESSARY APPROVALS BY PERMITTING AGENCIES.

THE LOCATION OF EXISTING UTILITIES WERE TAKEN FROM RECORDS AND MARKING PROVIDED BY OTHERS AND OBSERVED EVIDENCE. THE LOCATIONS SHOWN MAY BE APPROXIMATE. THE CONTRACTOR IS RESPONSIBLE FOR DETERMINING THE EXACT LOCATIONS, SIZES AND DEPTH OF ALL UTILITIES PRIOR TO CONSTRUCTION. THE CONTRACTOR SHALL EXERCISE CARE TO AVOID DAMAGE TO ALL EXISTING UTILITIES.

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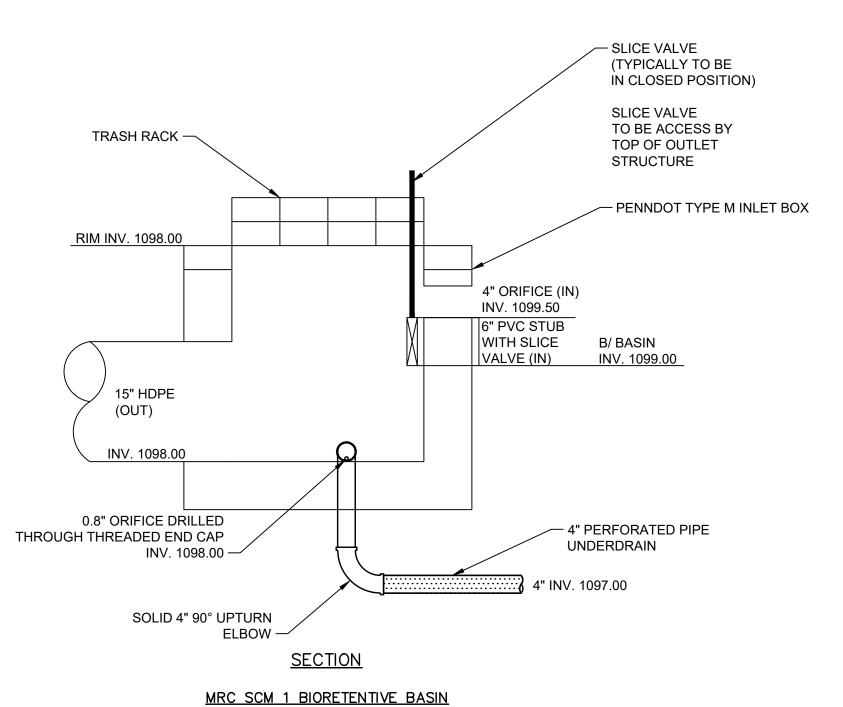
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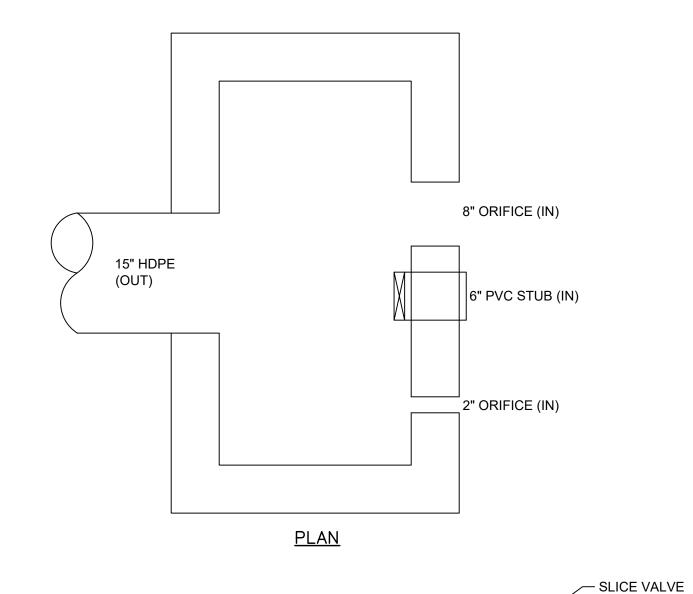
STORMWATER

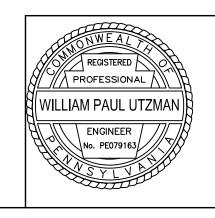
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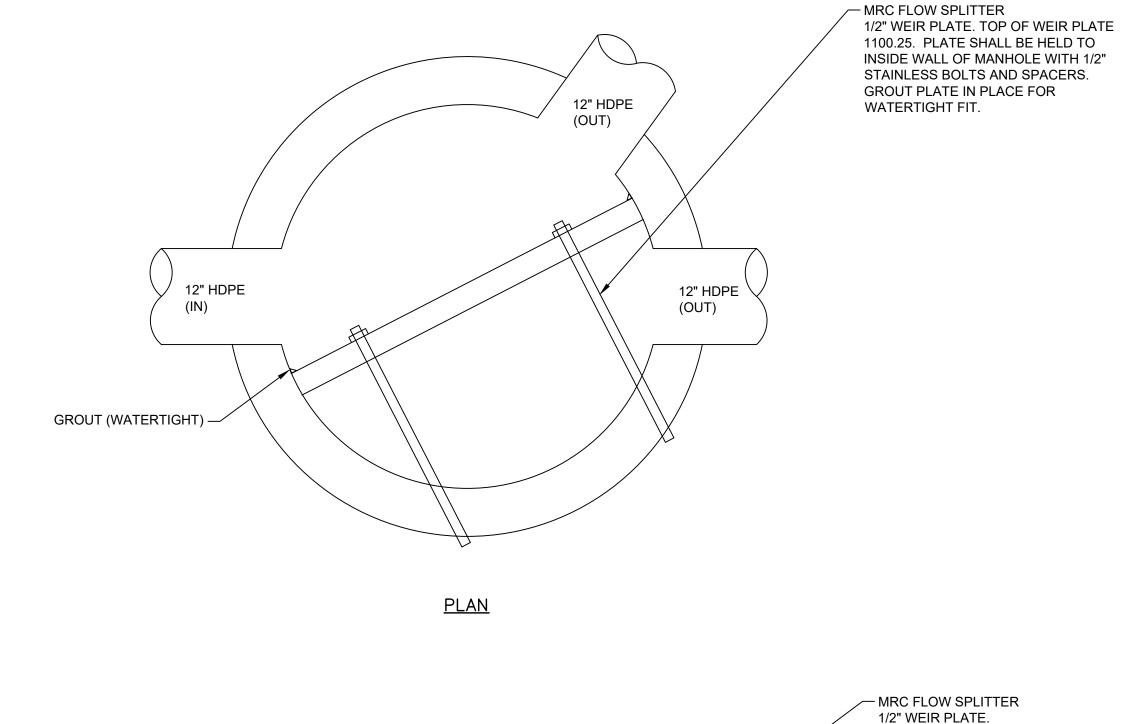



OUTLET CONTROL STRUCTURE DETAIL





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-8" ORIFICE (IN) 1099.10 6" PVC STUB WITH SLICE VALVE (IN) INV. 1097.00 — - 2" ORIFICE (IN) 1097.00

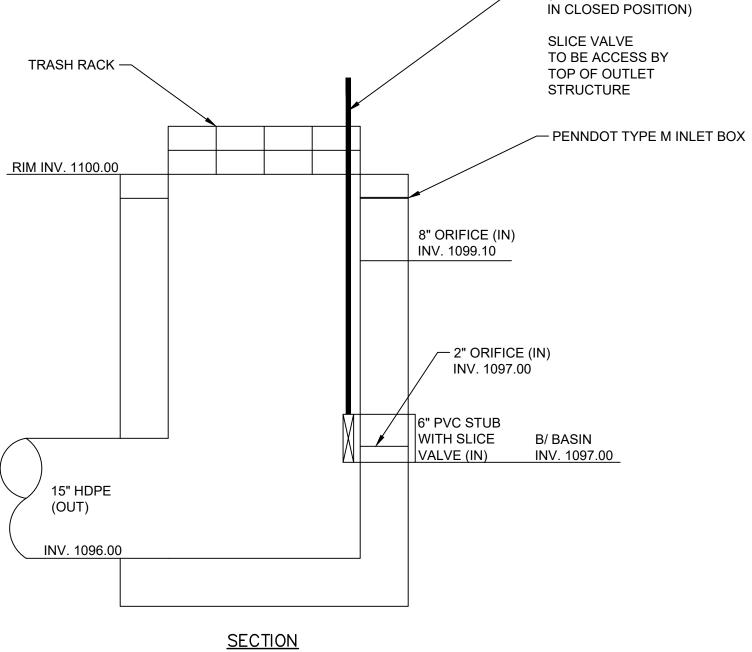**SECTION** 
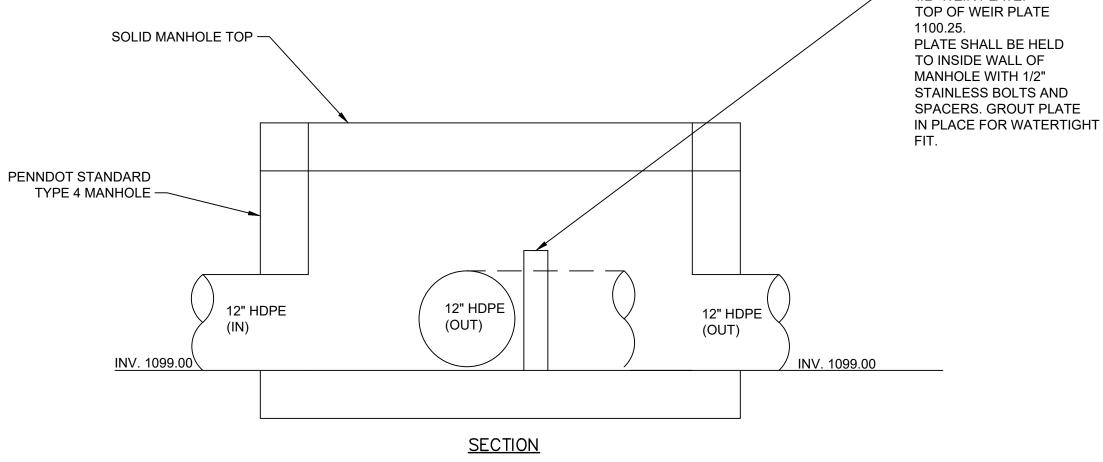
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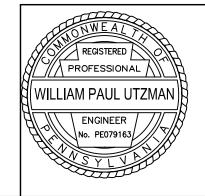
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THE GENERAL CONTRACTOR SHALL NOTIFY ALL UTILITY COMPANIES INVOLVED IN THE SITE NO MORE TEN DAYS AND NO LESS THAN THREE DAYS IN ADVANCE OF EXCAVATION (PA ACT 287 OF 1974 AMENDED BY ACT 50 OF 2018). PA STATE LAW REQUIRES 3 WORKING DAYS NOTICE

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