

NEW STANTON MANOR PA-18-27 EXTERIOR RENOVATIONS

PREPARED FOR

WESTMORELAND COUNTY HOUSING AUTHORITY


167 GREENGATE ROAD GREENSBURG, PA 15602

DECEMBER 13, 2024 R24-077-01

ISSUED FOR BIDDING



SITE LOCATION

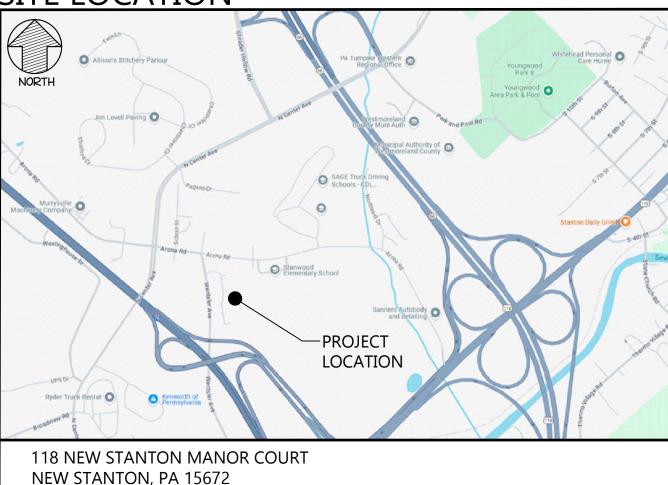

DRAWING LIST

GO.01 COVER SHEET

Architectural

A1.00 OVERALL SITE PLAN
A1.01 FOUNDATION & BASEMENT FLOOR PLANS - BUILDING A

1.02 FIRST & SECOND FLOOR PLANS - BUILDING A
1.03 FOUNDATION & BASEMENT FLOOR PLANS - BUILDING B

A1.04 FIRST & SECOND FLOOR PLANS - BUILDING B

A1.05 FOUNDATION & BASEMENT FLOOR PLANS - BUILDING C A1.06 FIRST & SECOND FLOOR PLANS - BUILDING C

A1.06 FIRST & SECOND FLOOR PLANS - BUILDING C
A1.07 PLANS & ELEVATIONS - COMMUNITY BUILDING

A2.01 ELEVATIONS - BUILDING A

A2.02 ELEVATIONS - BUILDING B


A2.03 ELEVATIONS - BUILDING C


A4.01 WALL SECTIONS A5.01 DETAILS

48.01 WINDOW TYPES & DETAILS

SLEIGHTER DESIGN

UNIVERSITY BUSINESS PARK 1060 EBERLY WAY LEMONT FURNACE, PA 15456 724.438.4010 WWW.SLEIGHTERDESIGN.COM

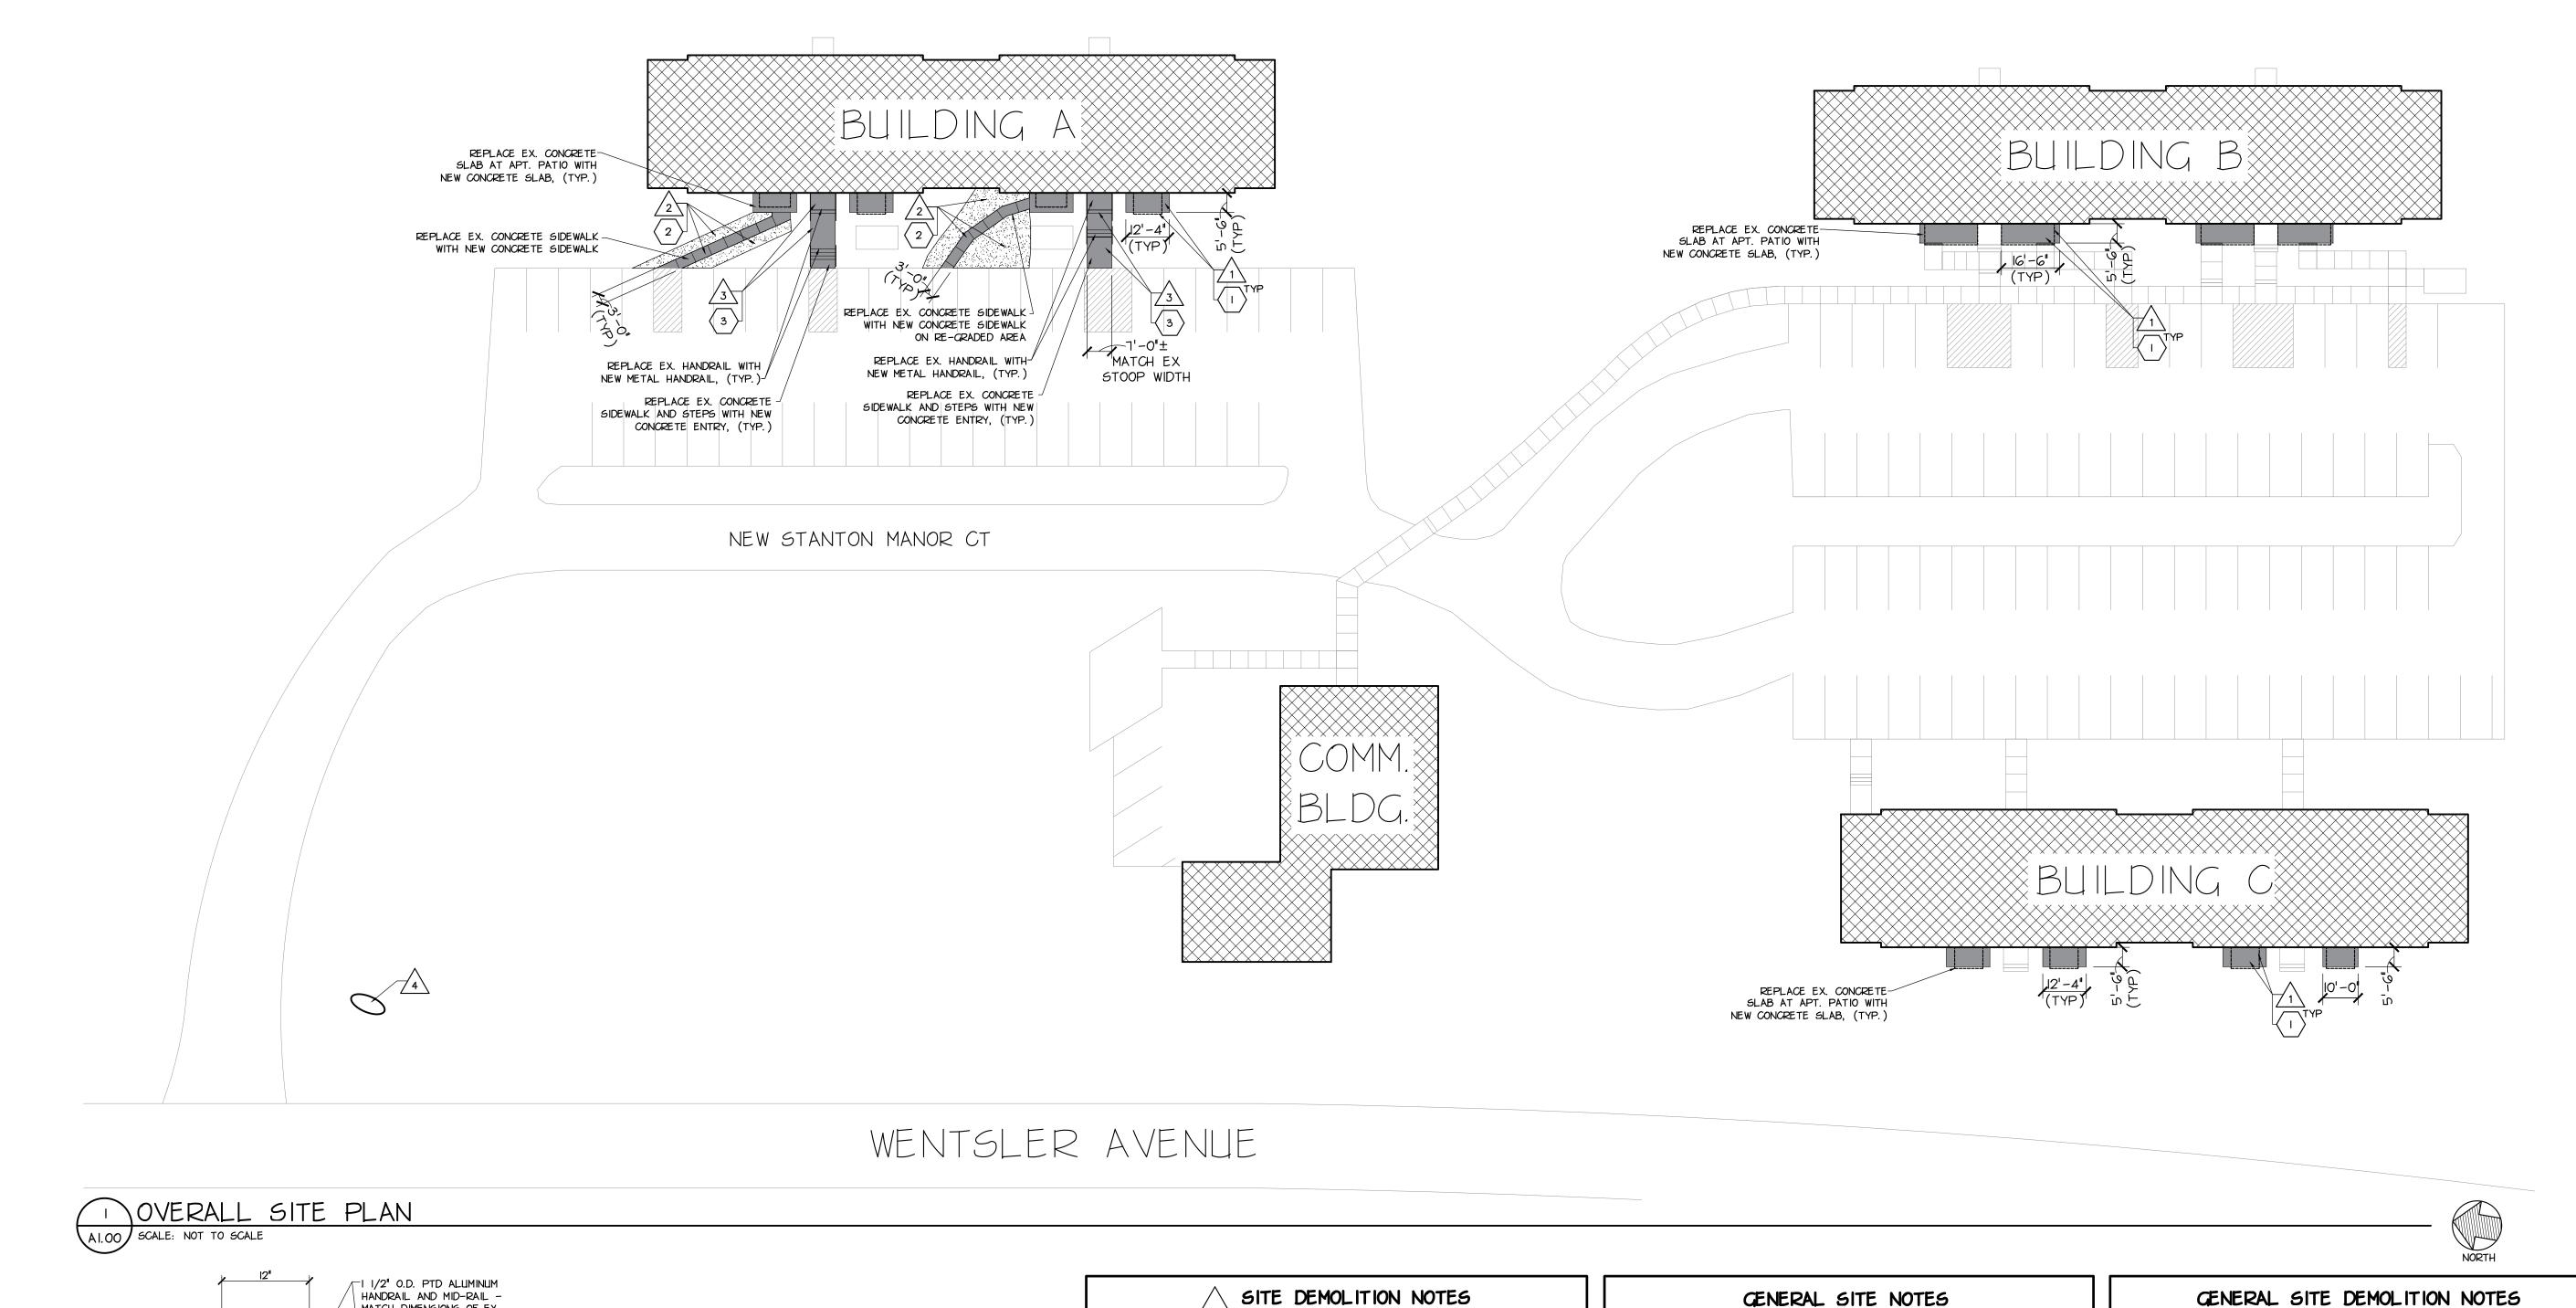

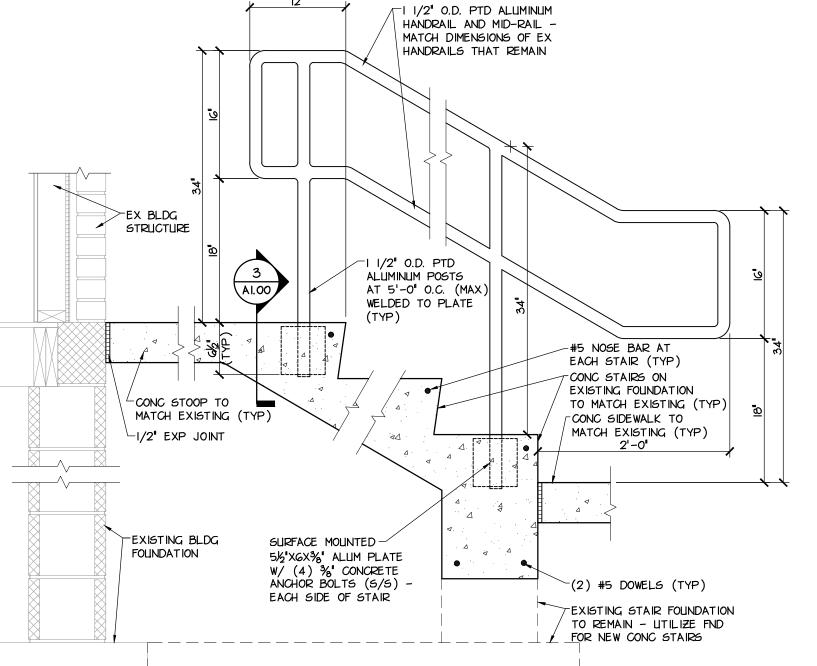

SITE DEMOLITION NOTES

 ⟨ GENERAL CONTRACTOR TO REMOVE EXISTING REINFORCED CONCRETE ightarrow slab-on-grade along with concrete frost wall and related reinforcing AT PATIOS. PREPARE AREA FOR INSTALLATION OF BALCONY FOLINDATIONS AS PART

 $^{\prime}$ 2 $^{\setminus}$ GENERAL CONTRACTOR TO REMOVE EXISTING CONCRETE SIDEWALK. REMOVE PARTS OF TREE ROOTS AND STUMP LEFT FROM PREVIOUSLY REMOVED TREE. RE-GRADE AREA TO ACHIEVE PROPER WATER DRAINAGE AWAY FROM BUILDING AND PATIO. PROVIDE CONCRETE SIDEWALK TO ALIGN WITH EXISTING CONDITIONS AT PATIO AND PARKING LOT AS PART OF NEW WORK.

3 GENERAL CONTRACTOR TO REMOVE EXISTING REINFORCED CONCRETE STAIRS, SIDEWALK AND STOOP ALONG WITH HANDRAIL AND RELATED FASTENERS. FOUNDATION FOR STOOPS ARE TO REMAIN. PROVIDE NEW REINFORCED CONCRETE STAIRS, SIDEWALK AND STOOP ALONG WITH HANDRAILS AS PART OF NEW WORK. ENSURE THAT PROPER ALIGNMENT AT ENTRY DOOR THRESHOLD AND PARKING LOT ARE MAINTAINED.

/4ackslash GENERAL CONTRACTOR TO CLEAN AND REMOVE DIRT AND RESIDUE FROM WCHA SITE SIGN/STONE. ENSURE THAT STONE IS SECURELY SEATED ON COMPACTED SOIL.

SITE CONSTRUCTION NOTES

| 火" DIA. ALUM. HANDRAIL W/ 比" RAILS & VERT

CONT WELD BETWEEN

5½'XGX%' ALUM PLATE WELDED TO VERT POST

LHANDRAIL CAP (ALUM)

WELDED TO HANDRAIL

(4) %"X5" HILTI CONC ANCHOR BOLTS (5/5)

YHANDRAIL DETAIL

HANDRAIL & PLATE

(EACH SIDE)

POSTS 5'-0" O.C. (MAX.)

- ackslash GC TO PROVIDE CONCRETE SLAB ON GRADE (PATIO) AS INDICATED ON BUILDING PLAN SHEETS AI.OI, AI.O3, AI.O5. PROVIDE COMPACTED BACKFILL AT AREAS OF OVER-EXCAVATION. PROVIDE 8' GRAVEL APRON AT PERIMETER OF PATIO UNLESS INDICATED OTHERWISE ON PLANS. ENSURE THAT SLAB SLOPES AWAY FROM EXISTING DOOR THRESHOLD.
- \langle $_2$ angle GC TO PROVIDE CONCRETE SIDEWALK (36" WIDE) FROM PARKING LOT TO ullet CONCRETE SLAB ON GRADE (PATIO). MATCH EXISTING CONDITIONS TO ENSURE
- 3 > GC TO PROVIDE CONCRETE STAIRS, SIDEWALK AND STOOP ALONG WITH HANDRAILS WHERE INDICATED ON THE SITE PLAN. ENSURE THAT HANDRAILS MEET REQUIREMENTS FOR THE NUMBER OF EXISTING TREADS AT EACH STAIR. GC TO PROVIDE ALL RELATED FASTENERS TO ENSURE A SECURE AND PLUMB INSTALLATION. MATCH EXISTING CONDITIONS FOR PROPER ALIGNMENT WITH BUILDING ENTRY DOOR THRESHOLD AND PARKING LOT. SEE HANDRAIL DETAIL 2 ON THIS SHEET.

GENERAL SITE NOTES

FIELD VERIFY ALL EXISTING CONDITIONS INCLUDING, BUT NOT LIMITED TO: DIMENSIONS, WINDOW SIZES, EXTERIOR MASONRY, SIDEWALK, STAIR, HANDRAILS AND AREAS OF NEW WORK. CONTRACTORS ARE RESPONSIBLE FOR REVIEWING THE COMPLETE SET OF CONSTRUCTION DOCUMENTS AND FIELD CONDITIONS TO DETERMINE THE FULL SCOPE OF WORK REQUIRED.

DRAWINGS ARE THE GRAPHIC AND PICTORIAL PORTIONS OF THE CONTRACT DOCUMENTS SHOWING THE DESIGN, LOCATION AND DIMENSIONS OF THE WORK. CONTRACTORS ARE TO REFER TO THE SPECIFICATIONS FOR THE WRITTEN REQUIREMENTS FOR MATERIALS, EQUIPMENT, CONSTRUCTION SYSTEMS, STANDARDS FOR WORKMANSHIP OF THE WORK, AND PERFORMANCE OF RELATED SERVICES.

THE INTENT OF THE CONTRACT DOCUMENTS IS TO INCLUDE ALL ITEMS NECESSARY FOR THE PROPER EXECUTION AND COMPLETION OF THE WORK BY THE CONTRACTORS. THE CONTRACT DOCUMENTS ARE COMPLIMENTARY, AND WHAT IS REQUIRED BY ONE SHALL BE BINDING AS IF REQUIRED BY ALL.

- DO NOT SCALE DRAWINGS.
- ALL DIMENSIONS INDICATED ON DRAWINGS ARE TAKEN TO THE FINISHED SURFACE. ALL WORK NOTED ON THE DRAWINGS IS TO BE DONE BY THE GENERAL CONTRACTOR UNLESS SPECIFICALLY NOTED OTHERWISE.
- WHERE INDICATED, "PROVIDE" MEANS TO "FURNISH AND INSTALL".
- ALL DIMENSIONS SHALL BE FIELD VERIFIED PRIOR TO CONSTRUCTION OR SUBMISSION OF ANY SHOP DRAWINGS. ANY DISCREPANCIES SHOULD BE REPORTED TO THE ARCHITECT LIPON DISCOVERY.
- IF THERE IS A CONFLICT ON THE DRAWINGS, THE CONTRACTOR SHALL PROVIDE THE GREATER QUANTITY OR THE GREATER QUALITY.

ALL DEMOLITION DEBRIS, WASTE MATERIAL, EXCESS FILL, TREES, LIMBS, ROOTS,

RUBBISH, AND TRASH IS TO BE CONTAINERIZED ON SITE AS GENERATED. THE GENERAL CONTRACTOR SHALL PROVIDE AND MAINTAIN ROLL-OFF BOX(ES) AND/OR OTHER SLITABLE MEANS TO COLLECT AND CONTAINERIZE DEMOLITION

THE GENERAL CONTRACTOR SHALL IMMEDIATELY REMOVE FROM THE SITE, TRANSPORT AND DISPOSE AT AN APPROVED OFF SITE DISPOSAL FACILITY, ALL ROLL-OFF BOX(ES) AND/OR DUMPSTER(S) WHEN FULL. THIS MAY INCLUDE BUT NOT BE LIMITED TO BUILDING AND SITE DEMOLITION DEBRIS.

THE OWNER SHALL BE GIVEN THE OPPORTUNITY TO COLLECT AND RETAIN AT THEIR FACILITY ANY ITEMS TO BE REMOVED ON THIS PROJECT. THIS MAY INCLUDE BUT NOT BE LIMITED TO DOORS, DOOR HARDWARE, WINDOWS, WINDOW HARDWARE, ELECTRICAL FIXTURES, APARTMENT NUMBERS, MAILBOXES, ETC. CONTRACTOR(S) SHALL COORDINATE DEMOLITION WORK WITH, AND NOTIFY THE OWNER, PRIOR TO REMOVAL OF ITEMS FROM SITE.

EXAMINE EXISTING CONDITIONS PRIOR TO COMMENCEMENT OF WORK, INCLUDING, BUT NOT LIMITED TO, ELEMENTS SUBJECT TO DAMAGE OR MOVEMENT DURING CUTTING AND PATCHING. FIELD VERIFY ALL EXISTING DIMENSIONS AND CONDITIONS. CONTRACTORS ARE RESPONSIBLE FOR REVIEWING THE COMPLETE SET OF CONSTRUCTION DOCLIMENTS AND FIELD CONDITIONS TO DETERMINE THE FULL SCOPE OF WORK REQUIRED.

FURNISH PROTECTION FROM ELEMENTS FOR AREAS WHICH MAY BE EXPOSED BY UNCOVERING WORK. CONTRACTORS SHALL CONFINE ALL WORK, EQUIPMENT AND MATERIALS TO THE DESIGNATED WORK AREA.

GC TO PATCH AND/OR REPAIR PORTIONS OF EXISTING SURFACES WHICH ARE DAMAGED LIFTED, DISCOLORED OR SHOWING OTHER IMPERFECTIONS DUE TO THEIR WORK.

GENERAL CONTRACTOR IS RESPONSIBLE FOR ALL DEMOLITION LINLESS SPECIFICALLY INDICATED TO BE COMPLETED BY ELECTRICAL CONTRACTOR.

PROVIDE TEMPORARY SUPPORT TO ENSURE STRUCTURAL INTEGRITY OF THE WORK. PROVIDE DEVICES AND METHODS TO PROTECT OTHER PORTIONS OF PROJECT FROM DAMAGE. PROVIDE TEMPORARY, SAFE ACCESS TO APARTMENTS DURING CONSTRUCTION.

DRAWINGS ARE THE GRAPHIC AND PICTORIAL PORTIONS OF THE CONTRACT DOCLIMENTS SHOWING THE DESIGN, LOCATION AND DIMENSIONS OF THE WORK. CONTRACTORS ARE TO REFER TO THE SPECIFICATIONS FOR THE WRITTEN REQUIREMENTS FOR MATERIALS, EQUIPMENT, CONSTRUCTION SYSTEMS, STANDARDS FOR WORKMANSHIP OF THE WORK, AND PERFORMANCE OF RELATED SERVICES.

THE INTENT OF THE CONTRACT DOCUMENTS IS TO INCLUDE ALL ITEMS NECESSARY FOR THE PROPER EXECUTION AND COMPLETION OF THE WORK BY THE CONTRACTORS. THE CONTRACT DOCUMENTS ARE COMPLIMENTARY, AND WHAT IS REQUIRED BY ONE SHALL BE BINDING AS IF REQUIRED BY ALL.



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WESTMORELAND COUNTY HOUSING

AUTHORITY

PROJECT NUMBER R24-077-01

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OVERALL SITE PLAN

SHEET NUMBER

EXISTING OPENING FOR NEW WORK

GC TO REMOVE EXISTING WINDOWS ALONG WITH RELATED TRIM AND BLOCKING.
LIMIT DISTURBANCE TO EXISTING ADJACENT GWB. REMOVE EXISTING WINDOW
COVERINGS/BLINDS ALONG WITH HANGERS AND FASTENERS WITH CARE.
SET ASIDE FOR INSTALLATION AS PART OF NEW WORK. CLEAN AND PREPARE

AT COMMUNITY BUILDING, GC TO REMOVE ALL LAYERS OF EXISTING ROOF SHINGLES, ROOF SHEATHING, RIDGE VENTS, AND ROOFING FELT PAPER ALONG WITH ALL RELATED FASTENERS. ENSURE CARE IS TAKEN DURING SHEATHING REMOVAL TO LIMIT DAMAGE TO ROOF STRUCTURE THAT REMAINS. REMOVE EXISTING PIPE FLASHING BOOTS AT ALL ROOF PENETRATIONS. REMOVE EXISTING FURNACE EXHAUST FLUES AND FLASHING ALONG WITH RAIN RINGS. PREPARE AREA OF ROOF AND ALL ROOF PENETRATIONS FOR NEW WORK


CONSTRUCTION NOTES

GC TO PROVIDE ALLIMINIUM WINDOW STOREFRONT SYSTEM ALONG WITH ALL RELATED HARDWARE, TRIM AND BLOCKING. VERIFY EXISTING FRAMED OPENING ALONG WITH ALL EXISTING CONDITIONS PRIOR TO SHOP DRAWING SUBMITTAL. LIMIT DISTURBANCE TO ADJACENT EXISTING INTERIOR AND EXTERIOR FINISHES. SEAL & FINISH AROUND STOREFRONT FRAME TO ACHIEVE A SEAMLESS INSTALLATION. INSTALL EXISTING COVERINGS/BLINDS SET ASIDE DURING DEMOLITION. PROVIDE NEW FASTENERS TO ENSURE PROPER INSTALLATION. PROVIDE REPLACEMENT OR REPAIR IN KIND OF ANY EXISTING FINISHES DAMAGED DURING DEMOLITION AND/OR INSTALLATION.

GC TO PROVIDE ALUMINUM SINGLE-HUNG WINDOWS ALONG WITH ALL RELATED HARDWARE, TRIM AND BLOCKING. VERIFY EXISTING MASONRY OPENING ALONG WITH ALL EXISTING CONDITIONS PRIOR TO SHOP DRAWING SUBMITTAL. LIMIT DISTURBANCE TO ADJACENT EXISTING INTERIOR AND EXTERIOR FINISHES. SEAL & FINISH AROUND WINDOW FRAME TO ACHIEVE A SEAMLESS INSTALLATION. INSTALL EXISTING COVERINGS/BLINDS SET ASIDE DURING DEMOLITION. PROVIDE NEW FASTENERS TO ENSURE PROPER INSTALLATION. PROVIDE REPLACEMENT OR REPAIR IN KIND OF ANY EXISTING FINISHES DAMAGED DURING DEMOLITION

AND/OR INSTALLATION.

GC TO PROVIDE ARCHITECTURAL ROOF SHINGLES, ROOF SHEATHING, RIDGE VENTS, FELT PAPER, DRIP EDGE, SOFFIT, FASCIA AND RELATED FASTENERS. PROVIDE RIDGE SHINGLES OVER RIDGE VENT. PROVIDE VENTED SOFFIT. PROVIDE ICE AND WATER SHIELD UNDERLAYMENT AT ROOF PERIMETER, VALLEYS AND RIDGE VENTS. EXTEND UNDERLAYMENT 3 FEET PASSED INTERIOR WALL. PROVIDE ROOF OVERHANG EXTENSIONS AS INDICATED ON THE ROOF AND FRAMING PLANS ALONG WITH SECTION 5/A4.0I. INSTALL SHINGLES IN ACCORDANCE WITH MANUFACTURER'S RECOMMENDATIONS INCLUDING ALL COMPONENTS REQUIRED FOR MANUFACTURER WARRANTY. PROVIDE FLASHING BOOTS AT ALL ROOF PENETRATIONS. PROVIDE EXHAUST FLUES AND FLASHING. CLEAN, PREP AND PAINT ALL PLUMBING VENTS. ENSURE WATER-TIGHT INSTALLATION. REFER TO TYPICAL ROOF DETAILS ON SHEET A4.0I.

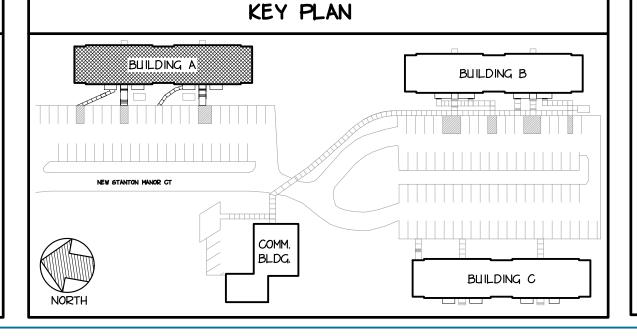

GENERAL DEMOLITION NOTES

- I. ALL DEMOLITION DEBRIS, WASTE MATERIAL, EXCESS FILL, TREES, LIMBS, ROOTS, RUBBISH, AND TRASH IS TO BE CONTAINERIZED ON SITE AS GENERATED.
- 2. THE GENERAL CONTRACTOR SHALL PROVIDE AND MAINTAIN ROLL-OFF BOX (ES) AND/OR
- OTHER SLITABLE MEANS TO COLLECT AND CONTAINERIZE DEMOLITION MATERIALS. '

 3. THE GENERAL CONTRACTOR SHALL IMMEDIATELY REMOVE FROM THE SITE, TRANSPORT
 AND DISPOSE AT AN APPROVED OFF SITE DISPOSAL FACILITY, ALL ROLL-OFF BOX(ES)
 - AND/OR DUMPSTER(S) WHEN FULL. THIS MAY INCLUDE BUT NOT BE LIMITED TO BUILDING AND SITE DEMOLITION DEBRIS.

 4. THE OWNER SHALL BE GIVEN THE OPPORTUNITY TO COLLECT AND RETAIN AT THEIR FACILITY AND LITTLE TO BE DEMONTOR ON THE DEPOLITION OF THE PROPERTY OF
- FACILITY ANY ITEMS TO BE REMOVED ON THIS PROJECT. THIS MAY INCLUDE BUT NOT BE LIMITED TO WINDOWS, WINDOW HARDWARE, ETC. CONTRACTOR(S) SHALL COORDINATE DEMOLITION WORK WITH, AND NOTIFY THE OWNER, PRIOR TO REMOVAL OF ITEMS FROM SITE.
- 5. EXAMINE EXISTING CONDITIONS PRIOR TO COMMENCEMENT OF WORK, INCLUDING, BUT NOT LIMITED TO, ELEMENTS SUBJECT TO DAMAGE OR MOVEMENT DURING CUTTING AND PATCHING. FIELD VERIFY ALL EXISTING DIMENSIONS AND CONDITIONS.
- FURNISH PROTECTION FROM ELEMENTS FOR AREAS WHICH MAY BE EXPOSED BY UNCOVERING WORK. CONTRACTORS SHALL CONFINE ALL WORK, EQUIPMENT AND MATERIALS TO THE DESIGNATED WORK AREA.
- GC TO PATCH AND/OR REPAIR PORTIONS OF EXISTING SURFACES WHICH ARE DAMAGED, LIFTED, DISCOLORED OR SHOWING OTHER IMPERFECTIONS DUE TO THEIR WORK.
- PROVIDE TEMPORARY SUPPORT TO ENSURE STRUCTURAL INTEGRITY OF THE WORK.

 PROVIDE DEVICES AND METHODS TO PROTECT OTHER PORTIONS OF PROJECT
- CC TO REMOVE WITH CARE EXISTING SIGNAGE, BUILDING NUMBER AND APARTMENT NUMBERS PRIOR TO MASONRY RESTORATION TO ALLOW ACCESS TO ALL FINISHES. INFILL EXISTING HOLES IN MASONRY AS PART OF RESTORATION. INSTALL (UPON COMPLETION OF RESTORATION) NEW BUILDING & APARTMENT NUMBERS AND FACILITY SIGN AS PART OF NEW WORK.
- O. GC TO REMOVE DAMAGED OR ROTTED EXTERIOR WALL SHEATHING, WOOD FRAMING, INSULATION BOARD, BATT INSULATION, GYPSUM WALL BOARD, SEALANT, ROOF FRAMING AND ROOF SHEATHING UNCOVERED DURING THEIR WORK. PROVIDE UNIT PRICE PER QUANTITY AS INDICATED IN SPECIFICATION SECTION 011270.
- II. GC TO REMOVE BROKEN OR DAMAGED BRICK ALONG WITH MORTAR BACK TO NEAREST JOINT. CLEAN AND PREPARE AREA OF REMOVAL FOR BRICK INFILL AS PART OF NEW WORK. CLEAN ALL BRICK AND MORTAR OF STAIN, PAINT, DIRT, ETC. AND PREPARE SURFACE FOR SEAL AS PART OF NEW WORK.
- 12. GC TO REMOVE SEALANT FROM EXISTING MASONRY CONTROL JOINT. CLEAN AND PREPARE JOINT FOR INSTALLATION OF SEALANT AND BACKER ROD AS PART OF NEW WORK.
- 13. GC TO REMOVE EXISTING GUTTERS AND DOWNSPOUTS ALONG WITH RELATED HANGERS AND FASTENERS AT ALL BUILDINGS. PROVIDE CONTINUOUS ALUM GUTTERS, DOWNSPOUTS, HANGERS AND FASTENERS AS PART OF NEW WORK.
- 14. GC TO REMOVE EXISTING SIDING ALONG WITH FASTENERS AND TRIM AT GABLE ENDS
 OF ALL BUILDINGS. REPLACE ANY DAMAGED OR ROTTED MATERIALS. PREPARE
 EXTERIOR SHEATHING FOR INSTALLATION OF NEW ALUM SIDING, FASTENERS AND TRIM
 AS PART OF NEW WORK.
- IS. GC TO REMOVE EXISTING BALCONIES IN THEIR ENTIRELY INCLUDING BUT NOT LIMITED TO FRAMING, DECKING, RAILING AND RELATED FASTENERS/HANGERS. ENSURE THAT CARE IS GIVEN WITH REMOVING FRAMING FROM EXISTING STRUCTURE. SAW-CUT SUPPORTS THAT EXTEND INTO EXISTING FLOOR STRUCTURE FLUSH WITH EXTERIOR SHEATHING. CLEAN AREA OF ALL DIRT AND DEBRIS AND PREPARE FOR INSTALLATION OF BALCONY STRUCTURE AS PART OF NEW WORK.
- IG. CC TO REMOVE EXISTING BRICK INFILL, MASONRY LINTEL, FLASHING, FASTENERS AND SEALANTS ABOVE HEAD OF BASEMENT AND FIRST FLOOR PATIO/BALCONY DOORS. REMOVE DEBRIS AND PREPARE OPENING FOR COMPOSITE PANEL ON STUD INFILL AS PART OF NEW WORK.
- 17. GC TO REMOVE EXISTING THRU-WALL HVAC UNIT SLEEVE AND COVER ALONG WITH RELATED FASTENERS. CLEAN AND PREPARE OPENING FOR INSTALLATION OF BLANK PANEL INFILL AS PART OF NEW WORK. WHERE EXISTING HVAC UNITS ARE FOUND TO BE IN PLACE AND OPERATIONAL, CONTACT OWNER AND ARCHITECT.

GENERAL NOTES

- I. ALL DEMOLITION DEBRIS, WASTE MATERIAL, RUBBISH AND TRASH IS TO BE CONTAINERIZED ON SITE AS GENERATED. MAINTAIN ROLL-OFF BOXES OR OTHER SUITABLE MEANS TO COLLECT AND CONTAINERIZE DEMOLITION MATERIALS.
- 2. CONTRACTOR SHALL IMMEDIATELY REMOVE FROM THE SITE, TRANSPORT AND DISPOSE AT AN APPROVED OFF-SITE FACILITY, ALL ROLL-OFF BOXES AND/OR DUMPSTERS WHEN FILL.
- 3. CONTRACTOR SHALL EXAMINE EXISTING CONDITIONS PRIOR TO COMMENCEMENT OF WORK, INCLUDING BUT NOT LIMITED TO ELEMENTS OF BUILDING AND SITE SUBJECT TO DAMAGE AS A RESULT OF ROOF WORK.
- 4. FURNISH PROTECTION FROM ELEMENTS FOR AREAS WHICH MAY BE EXPOSED BY UNCOVERING WORK.
- 5. RESTORE ALL AREAS OF THE SITE AND BUILDING(S) NEGATIVELY IMPACTED BY

CONSTRUCTION ACTIVITIES UPON COMPLETION OF CONSTRUCTION WORK.

- 6. BUILDING TYPES AND QUANTITIES ARE SHOWN TO ASSIST THE CONTRACTORS IN BIDDING WORK. HOWEVER, MINOR VARIATIONS IN THE BUILDING TYPES ARE TO BE EXPECTED, THE CONTRACTOR IS TO INSPECT AND VERIFY ALL QUANTITIES IN THE FIELD PRIOR TO BIDDING.
- 1. REFER TO SHEET A8.01 FOR WINDOW TYPES AND DETAILS.

BRICK VENEER.

- . GC TO PROVIDE BUILDING NUMBERS AND APARTMENT NUMBERS. VERIFY ALL LOCATIONS WITH OWNER. PROVIDE FASTENERS FOR ADEQUATE ATTACHMENT TO BUILDING MATERIAL.
- 9. GC TO REPLACE ANY DAMAGED OR ROTTEN ROOF SHEATHING, ROOF FRAMING, WALL SHEATHING, WALL FRAMING, BATT INSULATION AND/OR RIGID INSULATION DISCOVERED.
- PROVIDE LINIT PRICING AS DEFINED IN SPECIFICATION SECTION 011270.

 10. GC TO REPLACE ALL DAMAGED, CRACKED, OR STAINED BRICK NOT ABLE TO BE CLEANED, ALONG WITH MORTAR, TO MATCH EXISTING ADJACENT BRICK. PROVIDE WATER-TIGHT INFILL TO ENSURE A SEAMLESS INSTALLATION. CLEAN AND SEAL ALL
- GC TO PROVIDE CONTINUOUS SEALANT AND BACKER ROD AT EXISTING MASONRY CONTROL JOINTS.
- 2. GC TO PROVIDE CONTINUOUS GUTTERS, DOWNSPOUTS, HANGERS AND RELATED FASTENERS. CONNECT TO EXISTING DOWNSPOUT BOOTS AT GRADE. ENSURE A WATER-TIGHT INSTALLATION OF COLLECTION ASSEMBLY.

INSTALLATION. LIMIT DISTURBANCE TO ADJACENT EXISTING FINISHES.

- GG TO PROVIDE ALUMINUM SIDING ALONG WITH HOUSE WRAP, TRIM, FASTENERS AND CONTINUOUS FLASHING ALONG TOP OF BRICK AT BUILDING GABLE ENDS. REPLACE ANY DAMAGED/ROTTEN SHEATHING, INSULATION, BLOCKING AND/OR FRAMING AS PART OF THE THIS INFILL. TRIM AND SEAL PERIMETER TO ENSURE PROPER WATER-TIGHT
- 4. GG TO PROVIDE BALCONIES AND PATIOS AS INDICATED ON PLANS, ELEVATIONS AND WALL SECTIONS. BALCONIES AND PATIOS ARE TO INCLUDE BUT NOT LIMITED TO FOUNDATIONS, CONCRETE SLAB, CONCRETE PIERS, STEEL COLUMNS, BEAMS, JOISTS, COMPOSITE DECKING, VINYL RAILING SYSTEM AND ALL RELATED HANGERS AND
- GC TO PROVIDE COMPOSITE BOARD INFILL ABOVE HEAD OF BASEMENT AND FIRST FLOOR PATIO AND BALCONY DOORS ALONG WITH FLASHING AND CONT SEALANT AT
- PERIMETER. ENSURE WATER-TIGHT SEAL AT INFILL.

 GC TO PROVIDE METAL BLANK-OFF PANEL LOUVER AT ALL EXISTING HVAC MASONRY
 OPENINGS. PROVIDE SHEATHING, STUD FRAMING, BLOCKING AND INSULATION AT THE

OPENING INFILL. ENSURE WATER-TIGHT SEAL ALONG PERIMETER AT INFILL.

- GC TO PROVIDE NEW FOUNDATION DRAIN PIPING WHERE CONCRETE FOUNDATIONS INTERRUPT CONTINUOUS RUN. ENSURE PROPER PITCH ALONG WITH WATER-TIGHT CONNECTION TO EXISTING PIPING. MATCH SIZE AND TYPE OF EXISTING FOUNDATION DRAIN PIPE.
- REFER TO ALOO OVERALL SITE PLAN FOR SITE DEMOLITION AND CONSTRUCTION.

 IF THERE IS A CONFLICT ON THE DRAWINGS, THE CONTRACTOR SHALL PROVIDE THE GREATER QUANTITY OR THE GREATER QUALITY.



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RENOVATIONS

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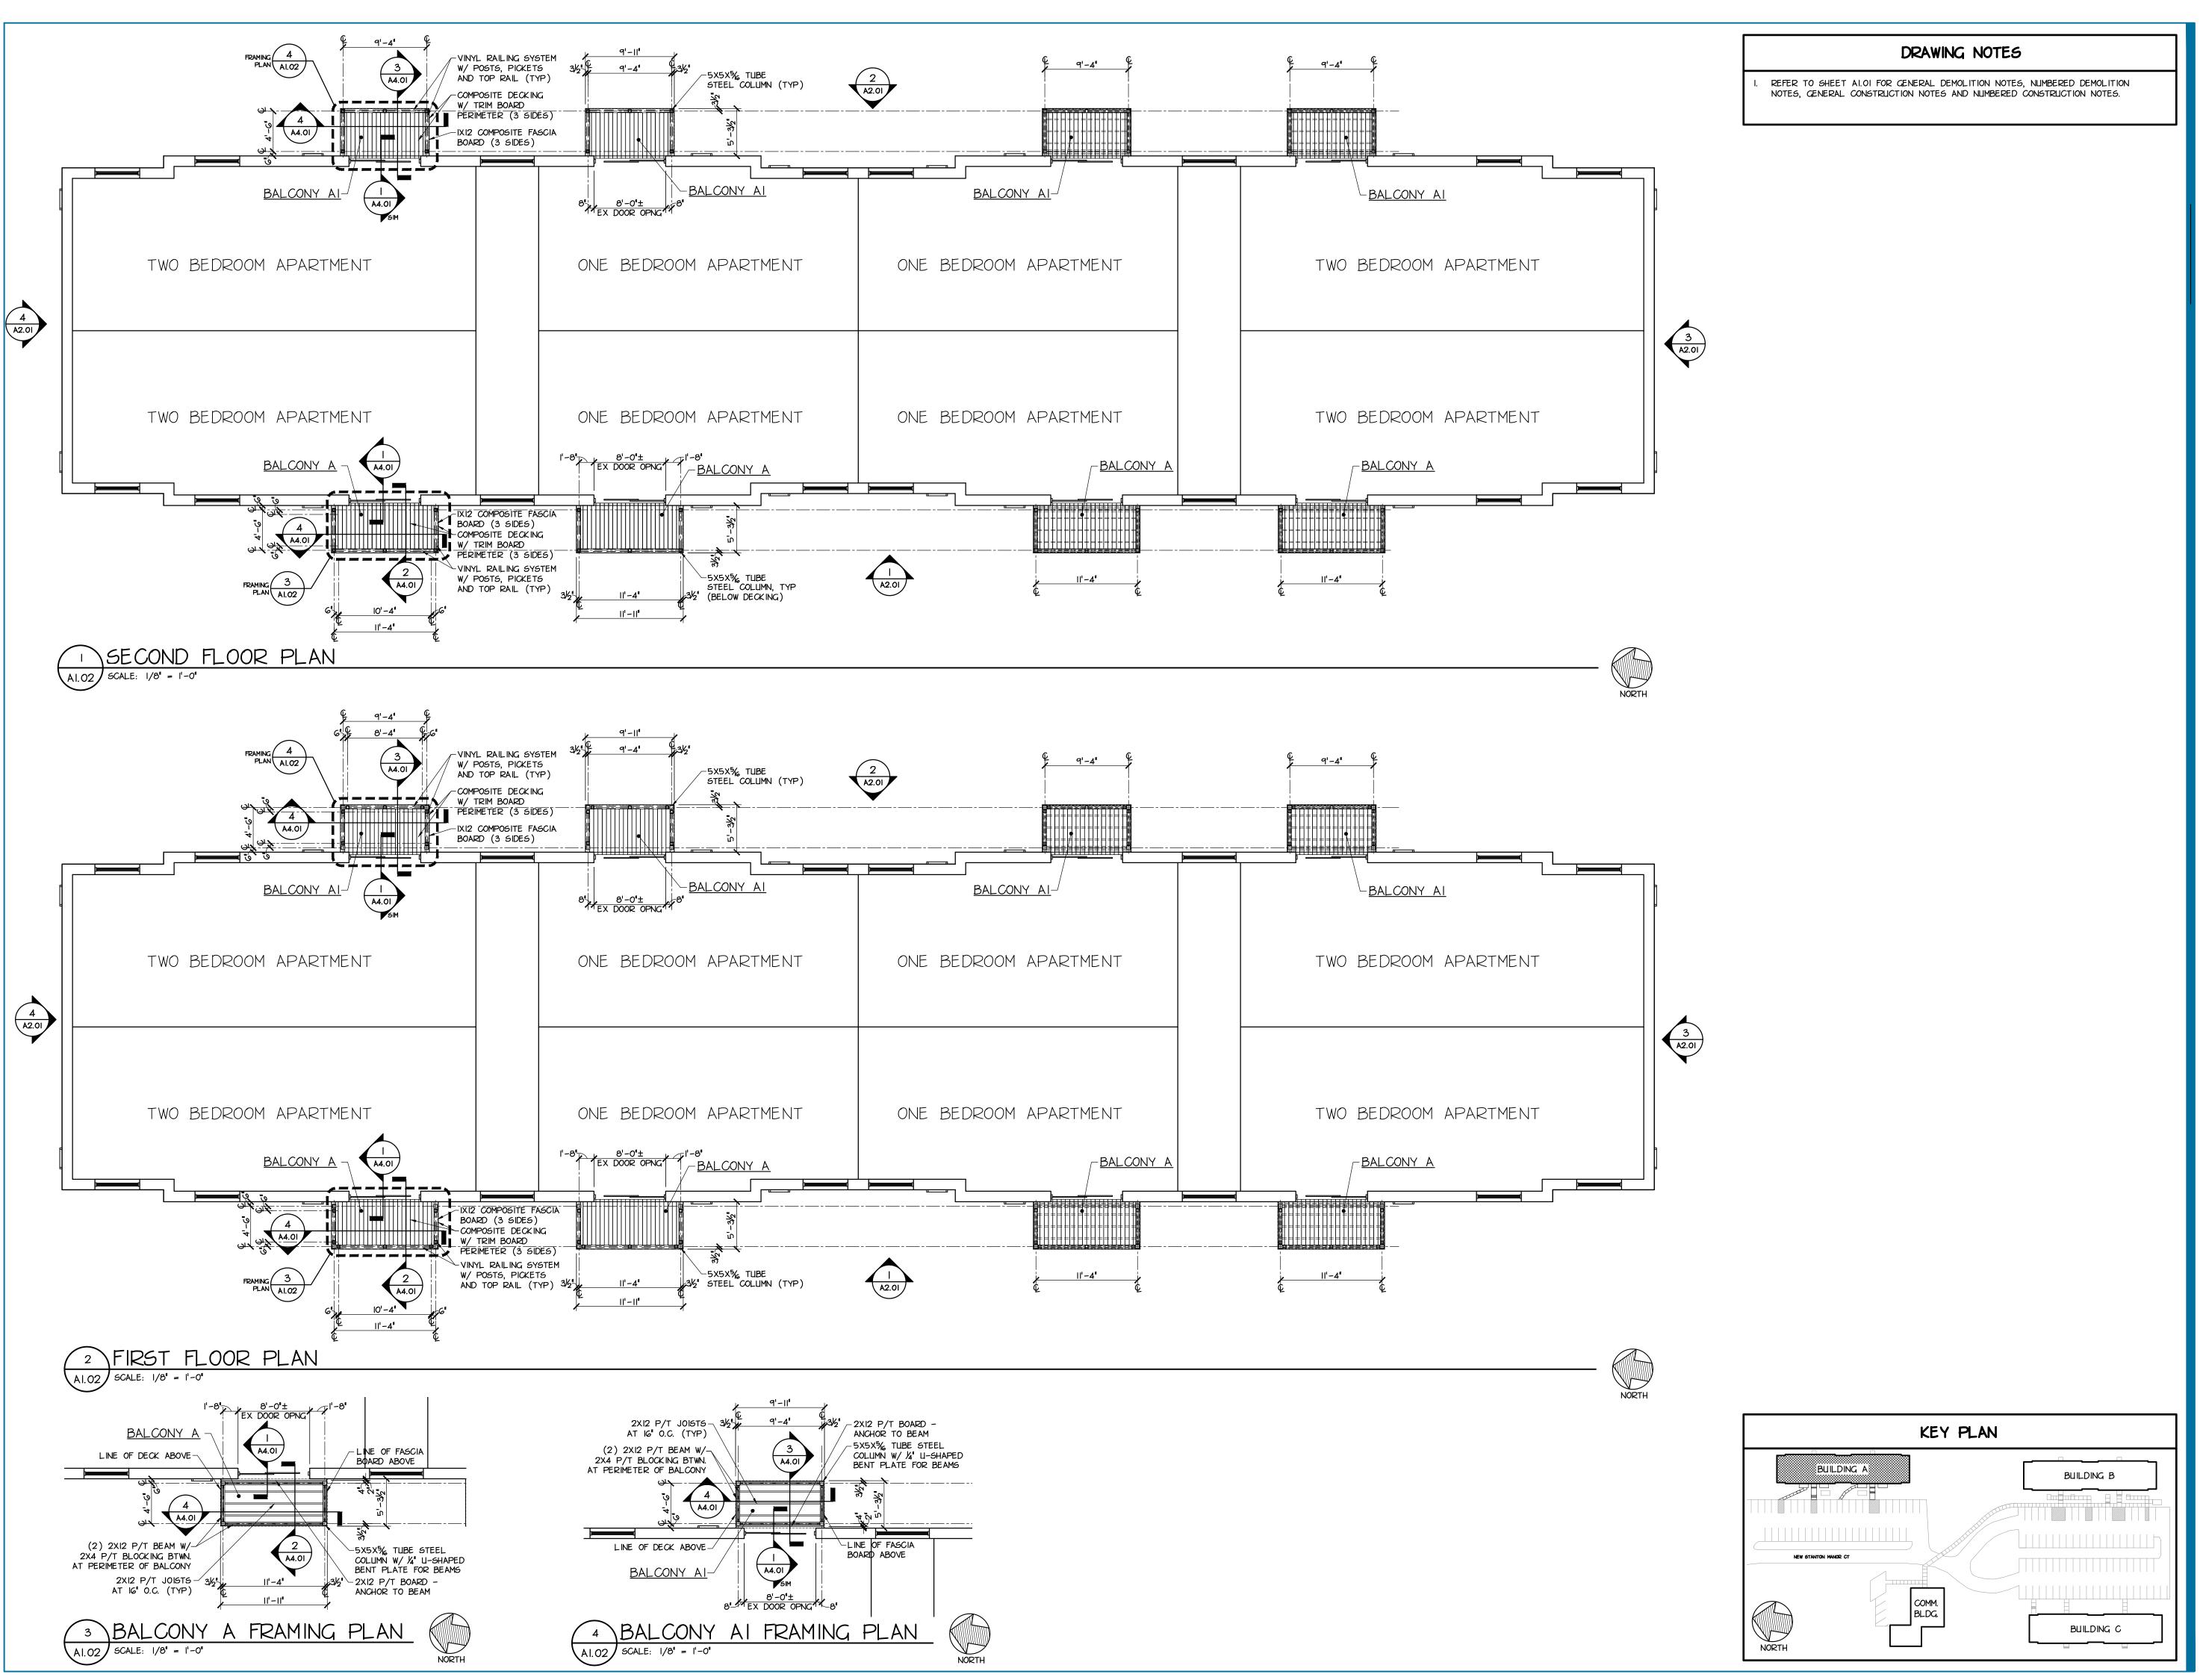
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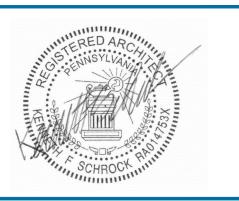
FND &
BASEMENT
FLR PLANS
BLDG A



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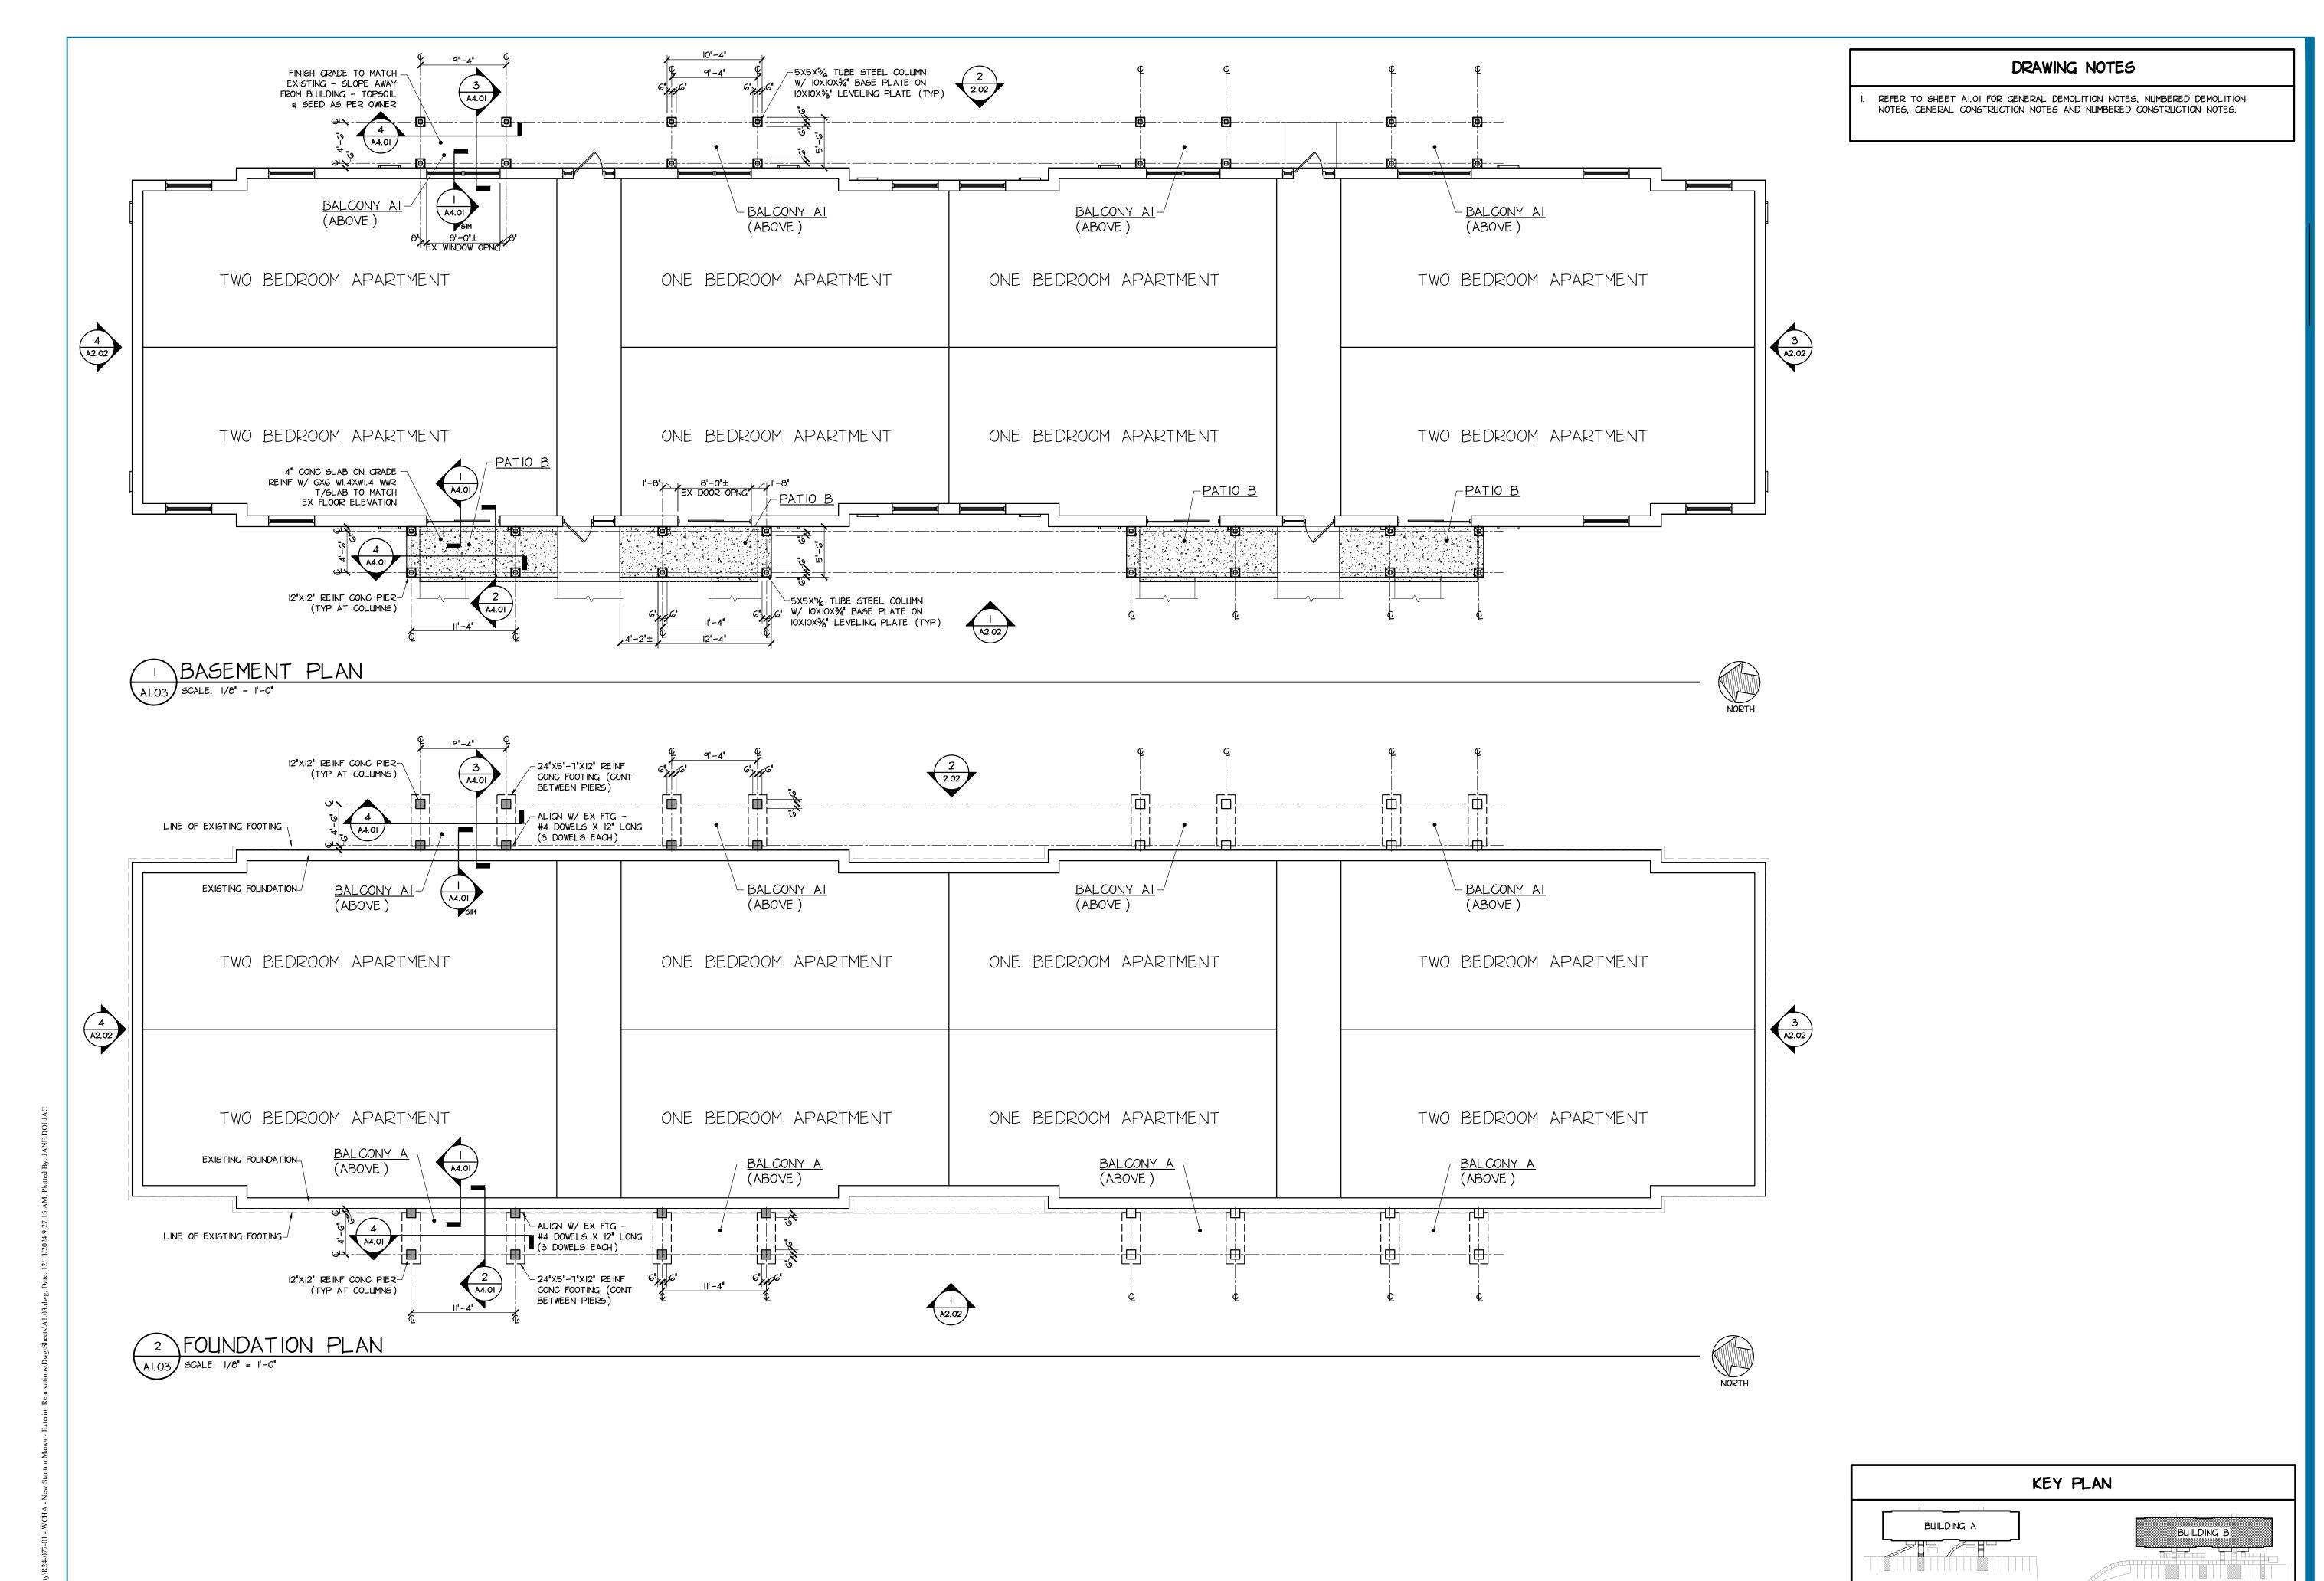
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1ST & 2ND FLR PLANS BLDG A


SHEET NUMBER



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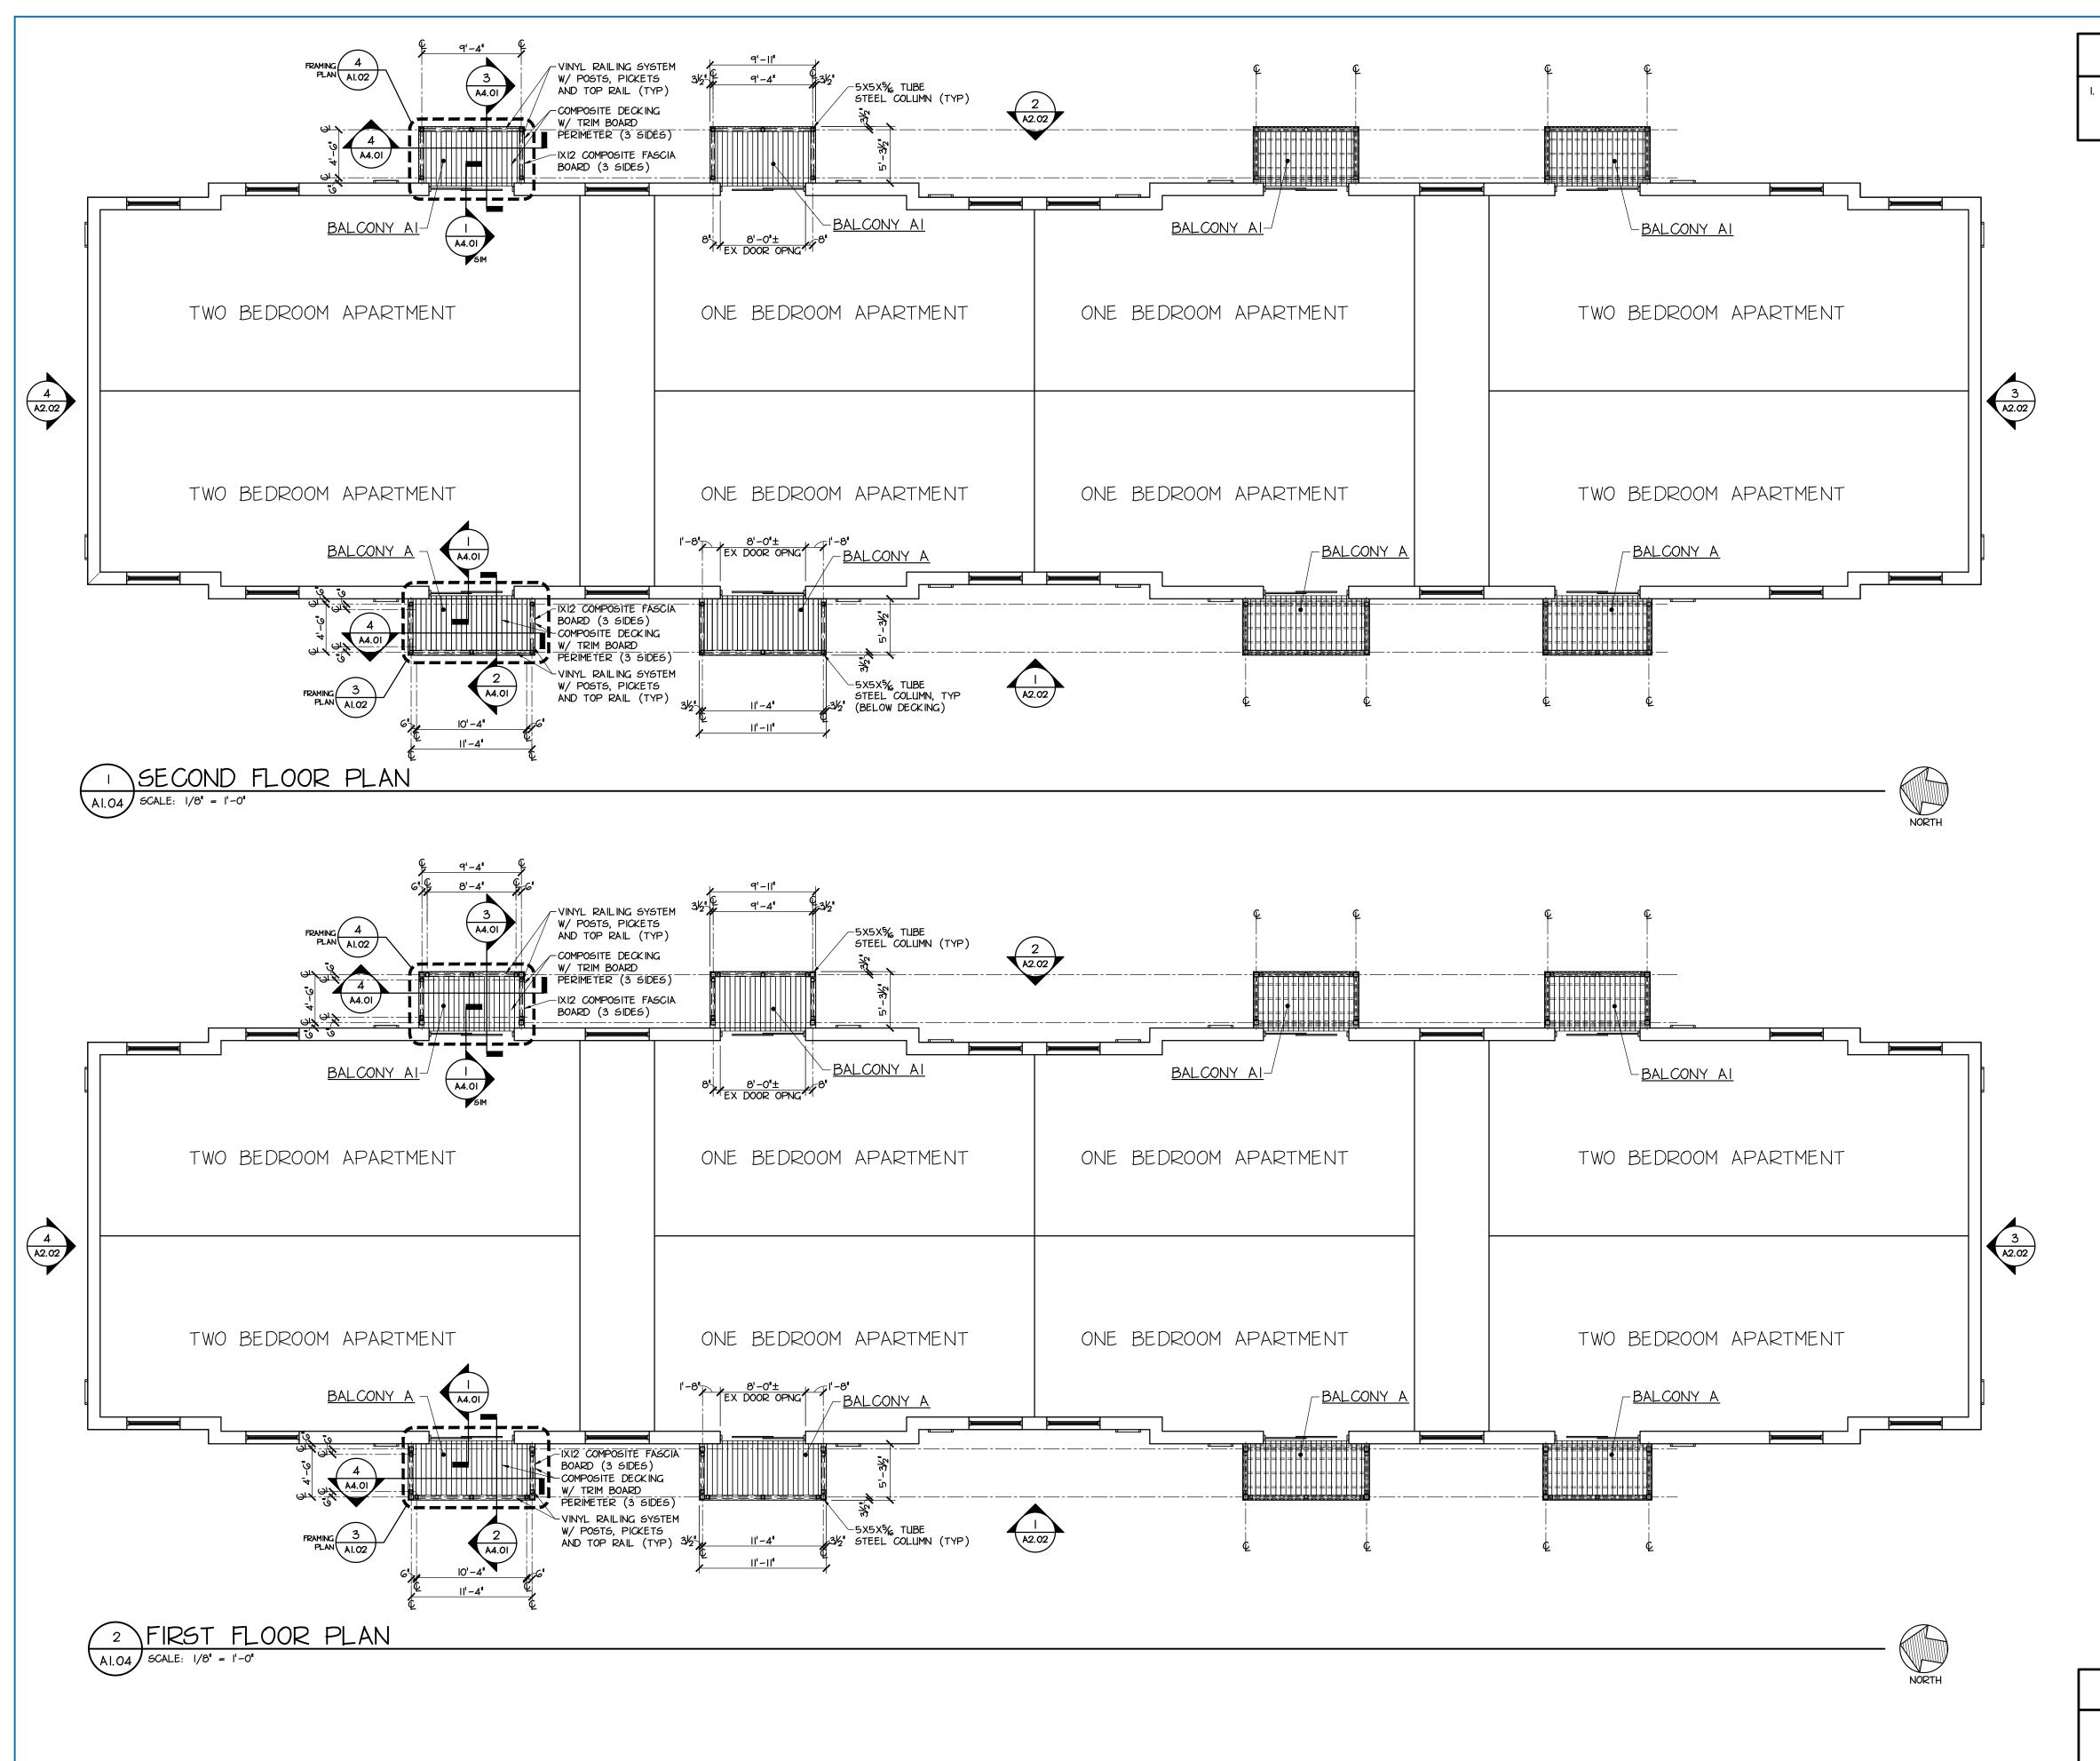
BIDDING

ISSUED FOR

BUILDING C

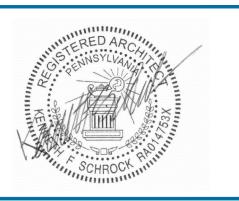DECEMBER 13, 2024

FND &
BASEMENT
FLR PLANS
BLDG B



DRAWING NOTES

REFER TO SHEET ALOI FOR GENERAL DEMOLITION NOTES, NUMBERED DEMOLITION NOTES, GENERAL CONSTRUCTION NOTES AND NUMBERED CONSTRUCTION NOTES.

KEY PLAN

BUILDING B

BUILDING C

BUILDING A


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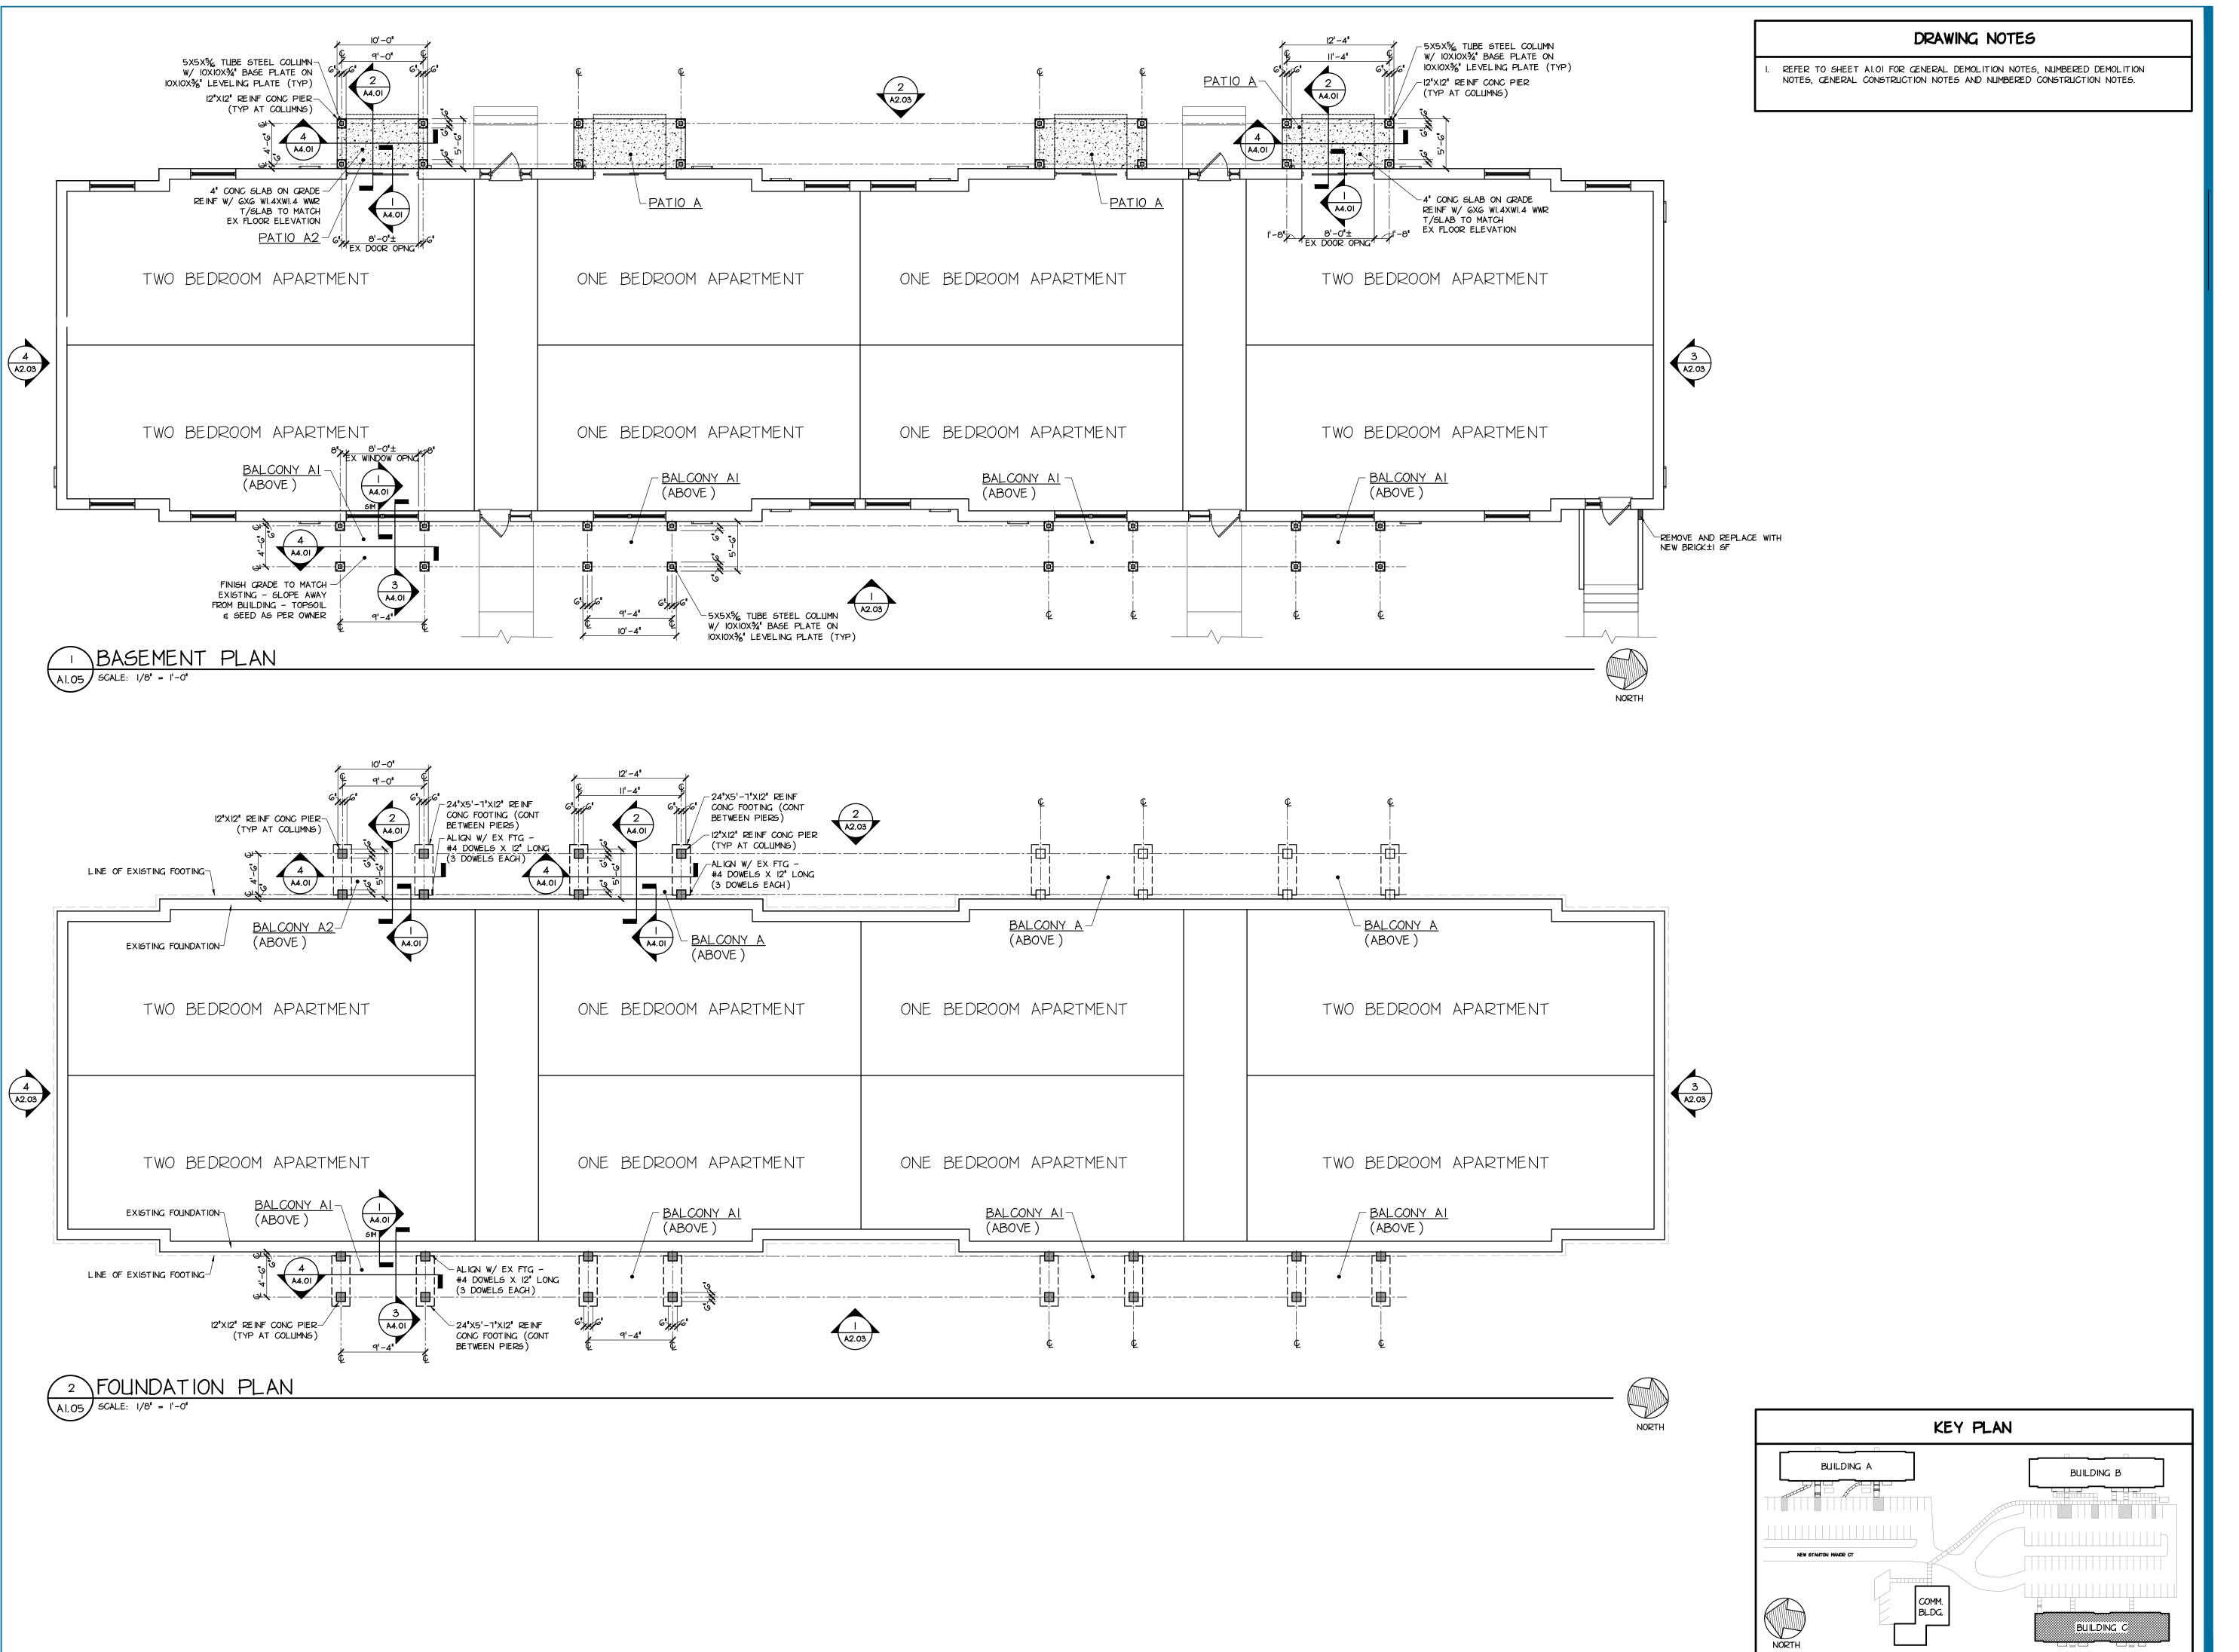
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1ST & 2ND FLR PLANS BLDG B

CHEET NILIMBEI





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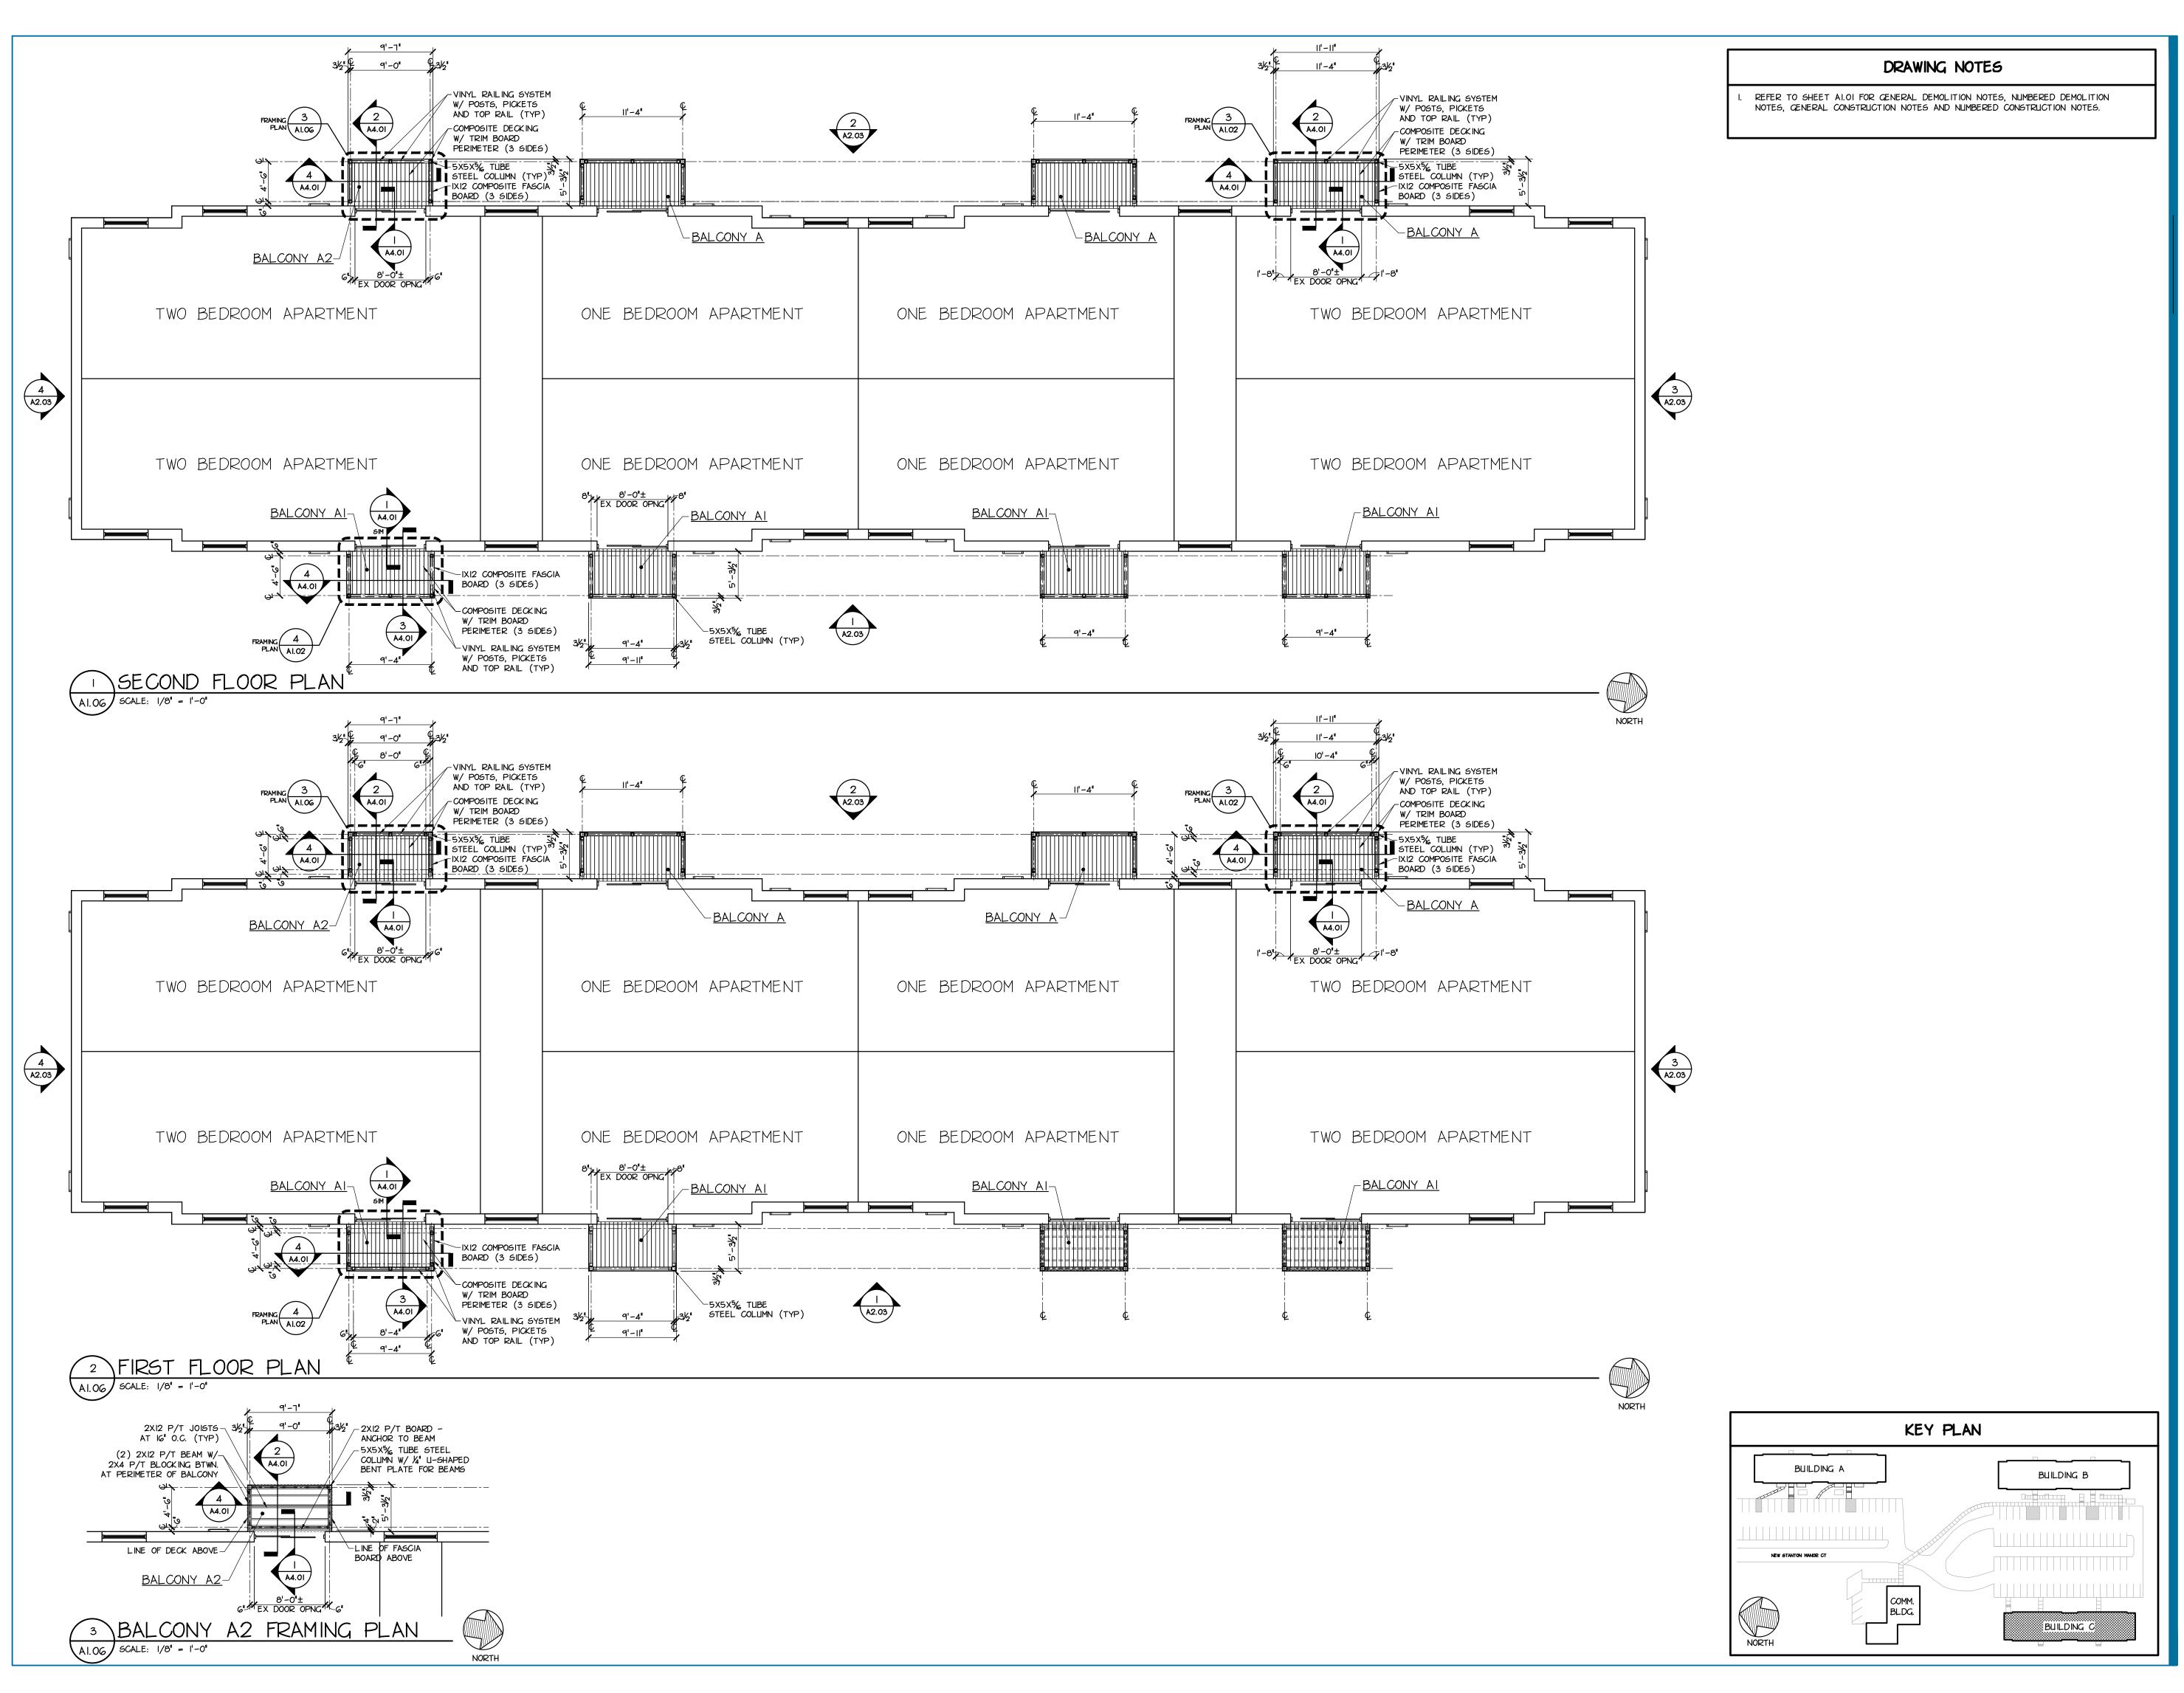
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FND & **BASEMENT** FLR PLANS BLDG C

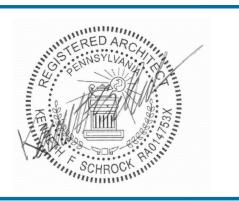
BUILDING C



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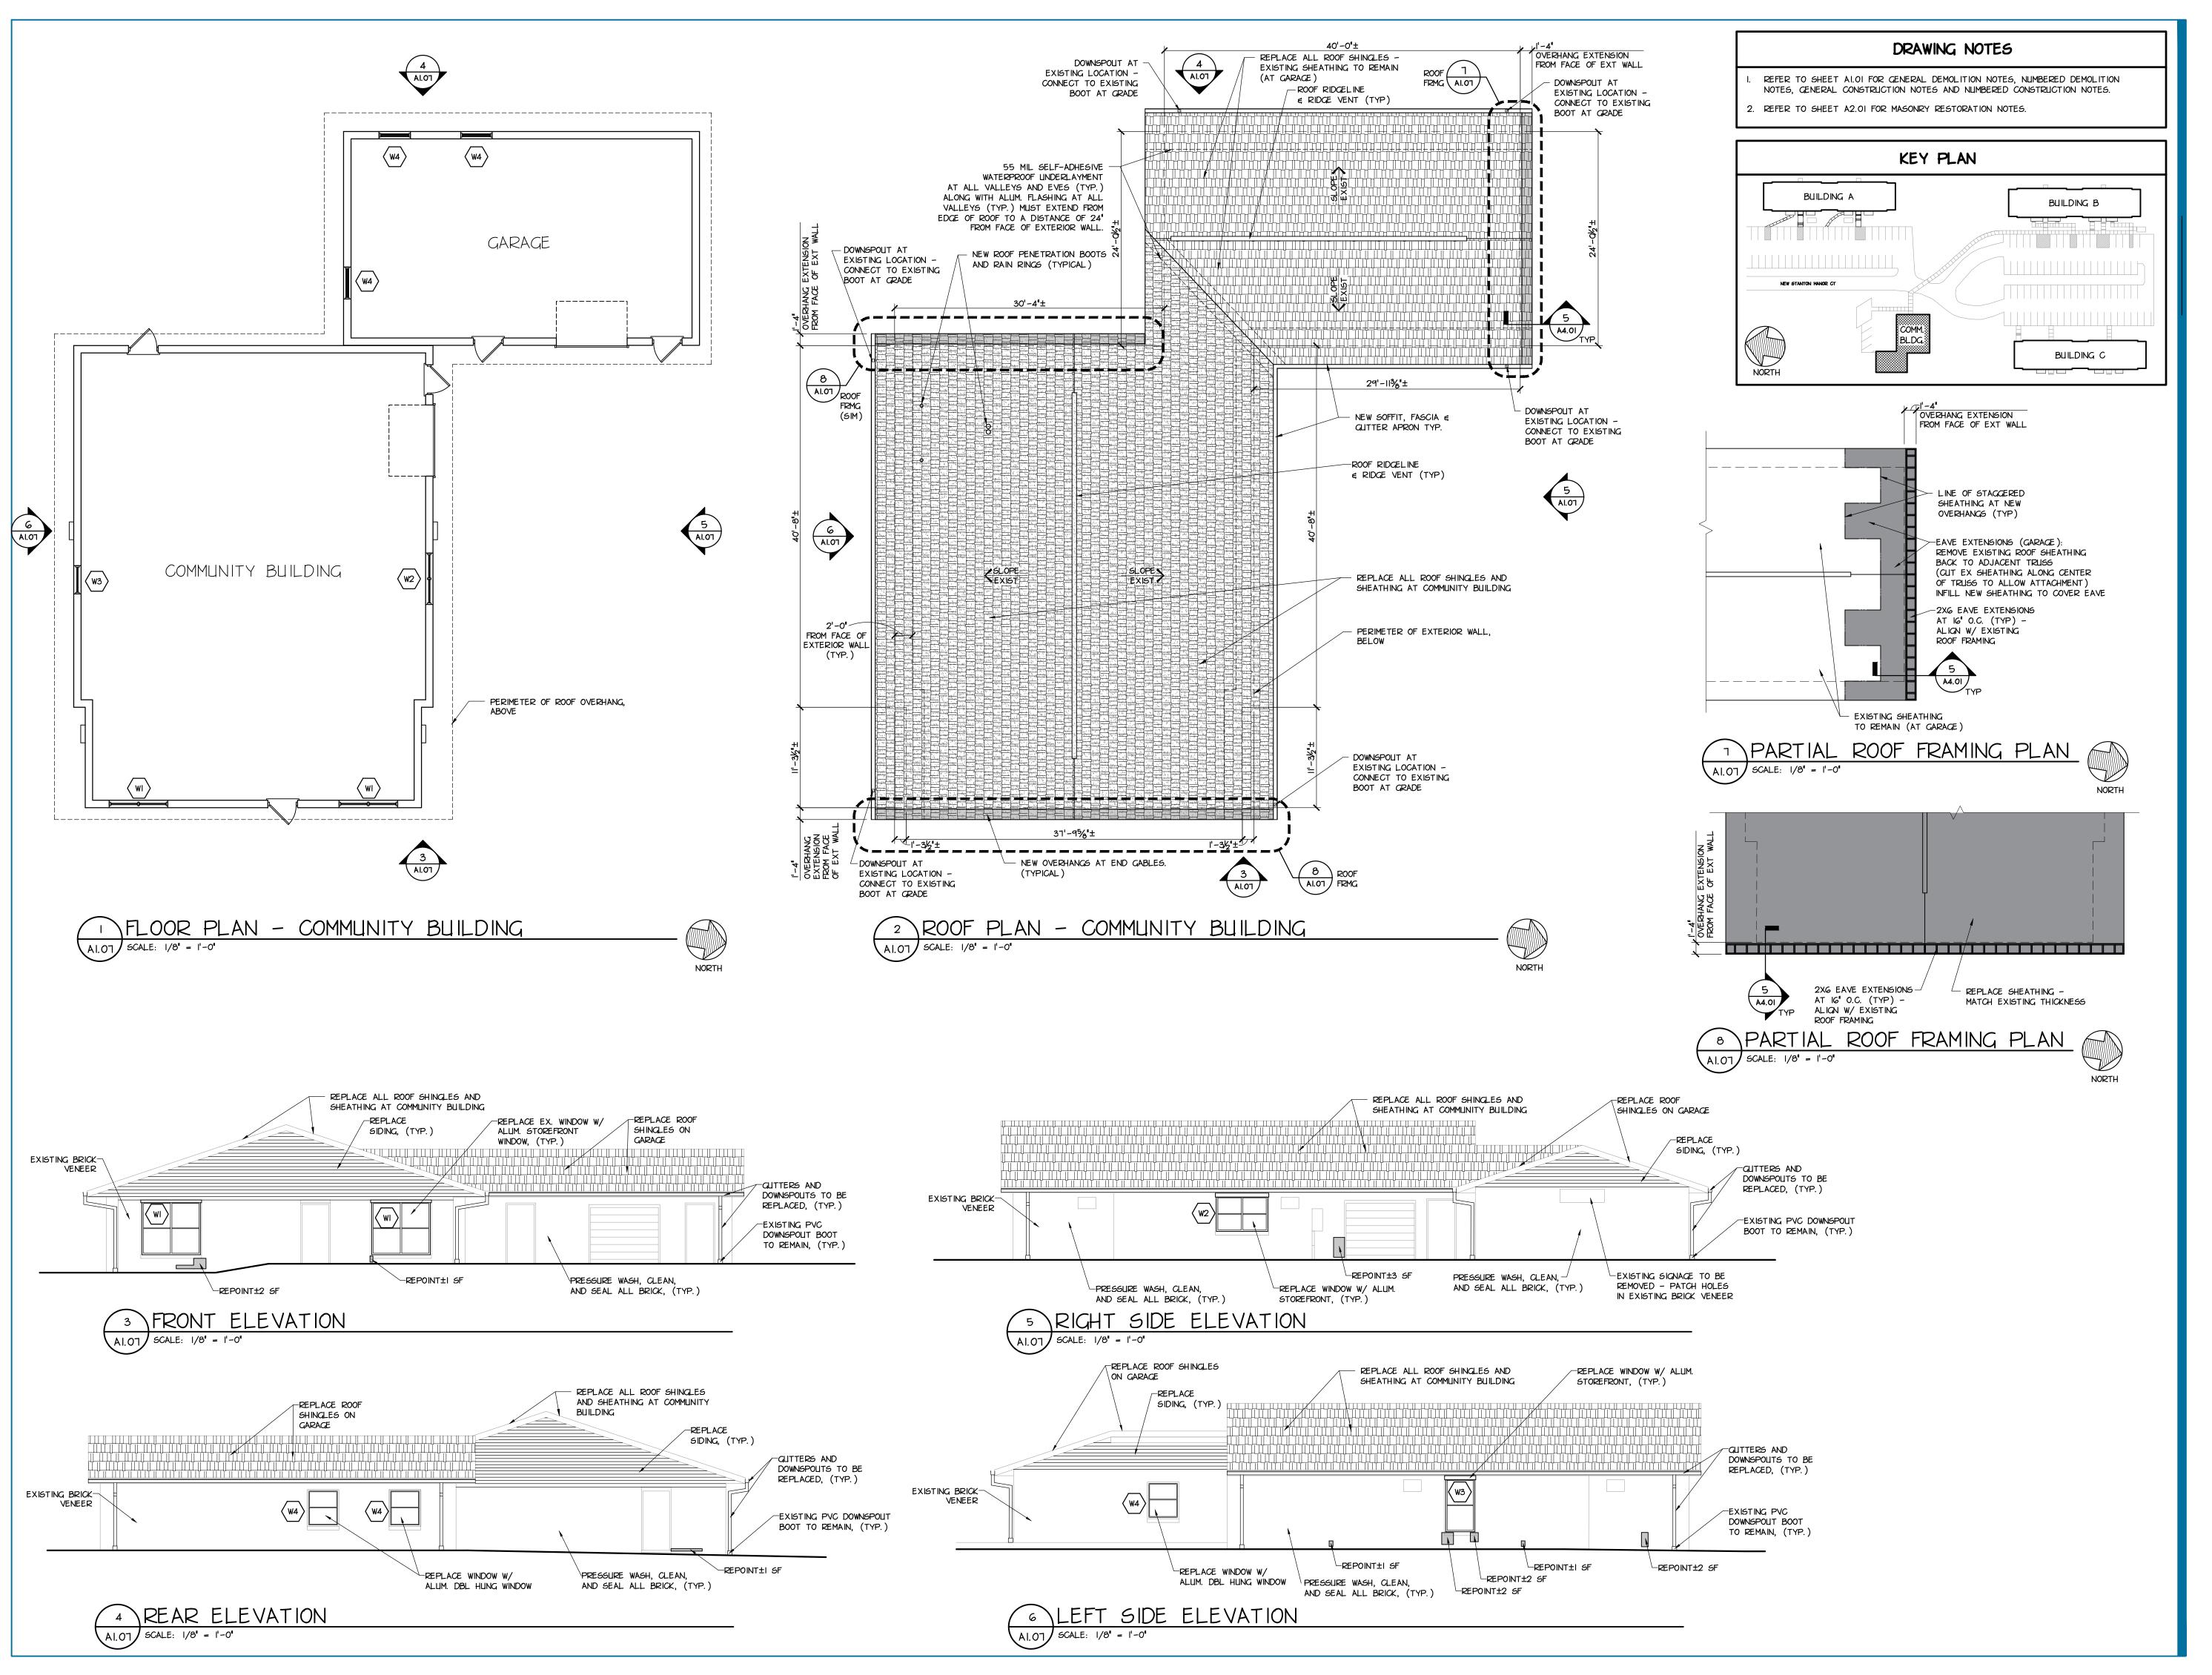
PROJECT NUMBER R24-077-01

BIDDING

DECEMBER 13, 2024

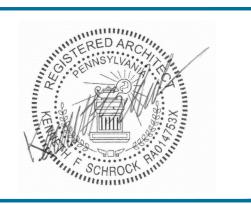1ST & 2ND FLR PLANS BLDG C

SHEET NUMBER





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NEW STANTON MANOR **EXTERIOR** RENOVATIONS

WESTMORELAND COUNTY HOUSING **AUTHORITY**

PROJECT NUMBER R24-077-01

ISSUED FOR BIDDING

DECEMBER 13, 2024

PLANS & ELEVATION COMM BLDG

SHEET NUMBER



AND SEAL

(TYP.)

-REPLACE

SIDING, (TYP.)

REPOINT±II SF

REMOVE HVAC SLEEVES &-

E INSUL PANEL (TYP.)

JOIST AND COMPOSITE

DECKING, (TYP.)

GUTTERS AND DOWNSPOUTS-TO BE REPLACED, (TYP.)

REMOVE HVAC SLEEVES &-

ER WITH INACTIVE LOUVER

STALL NEW BALCONIES W/-METAL POSTS, P/T 2XI2

> JOIST AND COMPOSITE DECKING, (TYP.)

€ INSUL PANEL (TYP.)

EXISTING BRICK

EXISTING ROOF SHINGLES-

AND SHEATHING

LREPOINT±1 SF

TRIGHT SIDE ELEVATION

EFT SIDE ELEVATION

COVER WITH INACTIVE LOUVER

INSTALL NEW BALCONIES W/

5X5 METAL POSTS, P/T 2XÍ2

ALL BRICK,

-EXISTING PVC

TO REMAIN,

PRESSURE

AND SEAL

ALL BRICK,

WASH, CLEAN,

-EXISTING PVC

TO REMAIN,

(TYP.)

DOWNSPOUT BOOT

(TYP.)

DOWNSPOUT BOOT

<u>SAFETY</u> THE CONTRACTOR SHALL PERFORM ALL WORK ACTIVITIES IN ACCORDANCE WITH SPECIFICATION SECTION OI 3500 SAFETY, AND ALL APPLICABLE HEALTH AND SAFETY REGULATIONS INCLUDING THOSE ESTABLISHED BY THE OCCUPATIONAL

SAFETY AND HEALTH ADMINISTRATION (OSHA) AND THE U.S. DEPARTMENT OF I) THE CONTRACTOR SHALL PROVIDE SIGNAGE AND BARRICADES TO SLIFFICIENTLY PROTECT RESIDENTS DURING OVERHEAD MASONRY RESTORATION ACTIVITIES. THIS INCLUDES THE INSTALLATION OF APPROPRIATE SCAFFOLDING AND SAFETY PLATFORMS OVER SIDEWALKS TO PROTECT RESIDENTS FROM FALLING DEBRIS.

EVERY EFFORT SHALL BE MADE BY THE CONTRACTOR TO INFORM AND PROTECT RESIDENTS FROM FALLING DEBRIS AND INJURY. 2) A DESIGNATED SAFETY OFFICER AS PROVIDED BY THE CONTRACTOR SHALL BE ONSITE DURING ALL OVERHEAD RESTORATION ACTIVITIES.

3) EMERGENCY DATA SHALL BE KEPT ONSITE FOR USE BY THE SAFETY OFFICER OR OTHERS AS NEEDED.

4) THE CONTRACTOR SHALL ABIDE BY THE SAFETY AGREEMENT BETWEEN OWNER AND CONTRACTOR WHICH IS PART OF SPECIFICATION SECTION 01-3500 SAFETY.

REPOINTING NOTES I)THOROUGHLY CLEAN THE MASONRY EXTERIOR OF THE BUILDING IN

ACCORDANCE WITH THE PROJECT REQUIREMENTS. 2) THIS PROJECT WILL INCLUDE PARTIAL REPOINTING OF THE EXTERIOR MORTAR JOINTS. ESTIMATES OF THE SQUARE FOOTAGE FOR EACH BUILDING FACE ARE

PROVIDED ON THE CONTRACT DRAWINGS. 3) THOROUGHLY INSPECT THE WORK AREA AND IDENTIFY RECTANGULAR AREAS WHICH WILL REQUIRE REPOINTING. INFORM THE OWNER AND ENGINEER OF THE GENERAL QUANTITY IN SQUARE FEET OF REPOINTING REQUIRED FOR EACH BUILDING FACE ONCE INSPECTED. THE INSPECTION SHOULD CONSIDER THE

ITEMS IDENTIFIED IN NOTE 4 BELOW. 4) REPOINT MORTAR JOINTS WHERE ANY OF THE FOLLOWING CONDITIONS OCCUR: A. MORTAR EROSION EXCEEDING 1/4" IN DEPTH B. CRUMBLING MORTAR

C. MORTAR WITH VOIDS D. HAIRLINE CRACKS (DEPTH OF 1/2" ACCEPTING THICKNESS EQUAL TO A

PLASTIC CREDIT CARD) IN MORTAR E. CRACKS BETWEEN THE BRICK AND MORTAR

5) SELECT MATERIALS AND CREATE AN APPROVED MOCKUP: ONCE THE ROUGH QUANTITIES ARE APPROVED FOR A SPECIFIC WORK AREA, PROCEED AS OUTLINED BELOW:

A.SELECT MORTAR MATERIALS OF APPROPRIATE STRENGTH AND APPEARANCE TO SUCCESSFULLY COMPLETE THIS PHASE OF THE WORK. B.PERFORM UP TO 3 - 48" X 48" MOCKUPS FOR THE OWNER AND ENGINEER TO REVIEW. REPOINTING WORK CANNOT PROCEED UNTIL THE FINAL MOCKUP IS APPROVED FOR COLOR, TEXTURE, AND JOINT FINISH.

6) MORTAR REMOVAL/JOINT PREPARATION: PROCEED WITH REMOVAL OF MORTAR JOINT MATERIAL TO A MINIMUM DEPTH OF 1/2" IN MANAGEABLE SECTIONS. UTILIZE APPROVED TOOLS AND METHOD. THOROUGHLY REMOVE THE OLD MORTAR WITHIN THE WORK AREA AND AVOID DAMAGE TO THE BRICK MASONRY UNITS. CLEAN THE RAKED JOINT OF ALL LOOSE PARTICLES BY

BRUSHING, RINSING WITH WATER, OR BLOWING WITH AIR. 1) PREPARE AND THOROUGHLY MIX THE APPROVED MORTAR FOR USE. THE APPROVED MORTAR SHOULD MEET THE REQUIREMENTS OF ASTM C 210. APPROVED MORTAR SHOULD BE PRE-HYDRATED TO REDUCE SHRINKAGE, SHOULD BE WATERTIGHT, AND SHOULD MATCH THE COLOR AND TEXTURE OF THE EXISTING BUILDING MORTAR.

8) MOISTEN THE WORK SURFACE AND APPLY THE APPROVED MORTAR MIX INTO THE JOINTS WITH A NARROW TUCKPOINTING TOOL IN 1/4" LIFTS. AVOID CREATING AIR POCKETS OR VOIDS. THE FINAL LIFT SHALL CREATE A CONCAVE TOOLED JOINT WITH A SMOOTH SURFACE THAT IS TIGHTLY COMPRESSED AND LANDS FLUSH WITH THE OUTSIDE EDGE OF THE BRICK. 9) REMOVE LOOSE MORTAR OR BURRS FROM THE WORK AREA USING A MASONRY

BRUSH. PROCEED TO THE NEXT WORK AREA AND REPEAT.

I) ESTABLISH A SAFETY ZONE AROUND AND UNDER THE WORK AREA. INSTALL BARRICADES AND WARNING SIGNS TO KEEP PEDESTRIANS FROM WANDERING INTO AND LINDER THE WORK AREA.

2) SELECT SUITABLE PRODUCTS (BRICK, MORTAR, ETC) AND PROVIDE A MOCKUP FOR REVIEW AND APPROVAL. 3) CONDUCT AN ASSESSMENT TO ESTABLISH THE LIMITS OF BRICK THAT NEEDS TO BE REMOVED AND REPLACED, AND MARK APPROPRIATELY.

REPLACEMENT. 5) RECONSTRUCT THE REMOVED BRICK IN SECTIONS INSTALLING BRICK TIES AT APPROVED INTERVALS AS YOU WORK. MATCH COURSING AND HEAD JOINTS

4) CAREFULLY REMOVE THE BROKEN OR DAMAGED BRICK IDENTIFIED FOR

WHERE POSSIBLE. 6) COMPLETE THE BRICK REPLACEMENT BY TOOLING THE MORTAR JOINTS TO MATCH EXISTING. USE A MASONRY BRUSH TO REMOVE BURRS AND PERFORM A

FINAL CLEANUP OF THE WALL 1) CLEANUP: REMOVE ANY EXCESS MORTAR OR DEBRIS FROM THE REPAIR AREA AND SURROUNDING AREAS. DISPOSE OF WASTE MATERIALS RESPONSIBLY AND ENSURE THAT THE WORK AREA IS LEFT CLEAN AND TIDY.

8) CONDUCT A FINAL INSPECTION OF THE REPAIR TO ENSURE THAT THE WORK HAS BEEN COMPLETED TO A HIGH STANDARD AND MEETS THE NECESSARY SPECIFICATIONS. MAKE ANY NECESSARY ADJUSTMENTS OR TOUCH-UPS AS NEEDED BEFORE CONSIDERING THE REPAIR COMPLETE.

CLEAN AND SEAL BRICK I) BEFORE STARTING, INSPECT THE BUILDING EXTERIOR AND PERFORM ANY

REPOINTING OR BRICK REPLACEMENT AS INDICATED BY THE CONTRACT DOCUMENTS. 2) COVER PLANTS, OUTDOOR FURNITURE, AND OTHER ITEMS NEAR THE

BUILDINGS TO PROTECT THEM FROM DETERGENT AND DEBRIS. 3) CLEAR THE AREA AROUND THE BUILDINGS TO ENSURE SAFE ACCESS. 4) FOLLOW THE MANUFACTURER'S INSTRUCTIONS FOR DILUTION AND APPLICATION OF THE DETERGENT CLEANER.

5) BEFORE STARTING, TEST THE PRESSURE WASHER IN AN INCONSPICUOUS AREA TO ENSURE IT'S SET TO AN APPROPRIATE PRESSURE AND WON'T DAMAGE THE

6) START FROM THE TOP OF EACH BUILDING AND WORK YOUR WAY DOWN TO PREVENT STREAKING. HOLD THE PRESSURE WASHER NOZZLE AT A 45-DEGREE ANGLE TO THE BRICK SURFACE TO AVOID DAMAGING THE MORTAR. WORK IN SMALL SECTIONS, OVERLAPPING EACH PASS SLIGHTLY TO ENSURE THOROUGH CLEANING. 1) FOR STUBBORN STAINS, USE A BRUSH OR SCRUBBER TO AGITATE THE

DETERGENT ON THE AFFECTED AREAS BEFORE RINGING WITH THE PRESSURE 8) ONCE YOU'VE CLEANED ALL SURFACES, RINSE THE BUILDINGS THOROUGHLY

WITH CLEAN WATER TO REMOVE ANY DETERGENT RESIDUE. 9) MIX OR PREPARE THE SEALER ACCORDING TO THE MANUFACTURER'S INSTRUCTIONS

10) USE A BRUSH, ROLLER, OR SPRAYER TO APPLY THE SEALER EVENLY TO THE CLEAN, DRY BRICK SURFACES, WORK IN SMALL SECTIONS. II) LET THE SEALER DRY COMPLETELY ACCORDING TO THE MANUFACTURER'S RECOMMENDATIONS BEFORE ALLOWING ANY CONTACT WITH THE SURFACES.

ACHIEVE A LINIFORM APPEARANCE. 13) ONCE THE SEALER IS DRY, INSPECT THE BUILDINGS FOR ANY MISSED SPOTS OR UNEVEN COVERAGE. TOUCH UP AS NEEDED. 14) CONDUCT A FINAL INSPECTION TO ENSURE ALL BUILDINGS ARE CLEAN, SEALED, AND FREE FROM ANY DAMAGE.

12) APPLY SEALANT AS RECOMMENDED IN A NUMBER OF COATS NECESSARY TO

GENERAL NOTES

- ALL DEMOLITION DEBRIG, WASTE MATERIAL, RUBBISH AND TRASH IS TO BE CONTAINERIZED ON SITE AS GENERATED. MAINTAIN ROLL-OFF BOXES OR OTHER SUITABLE MEANS TO COLLECT AND CONTAINERIZE DEMOLITION MATERIALS.
- CONTRACTOR SHALL IMMEDIATELY REMOVE FROM THE SITE, TRANSPORT AND DISPOSE AT AN APPROVED OFF-SITE FACILITY, ALL ROLL-OFF BOXES AND/OR DUMPSTERS WHEN FULL.
- CONTRACTOR SHALL EXAMINE EXISTING CONDITIONS PRIOR TO COMMENCEMENT OF WORK, INCLUDING BUT NOT LIMITED TO ELEMENTS OF BUILDING AND SITE SUBJECT TO DAMAGE AS A RESULT OF ROOF WORK.
- FURNISH PROTECTION FROM ELEMENTS FOR AREAS WHICH MAY BE EXPOSED BY LINCOVERING WORK.
- RESTORE ALL AREAS OF THE SITE AND BUILDING(S) NEGATIVELY IMPACTED BY CONSTRUCTION ACTIVITIES LIPON COMPLETION OF CONSTRUCTION WORK.
- BUILDING TYPES AND QUANTITIES ARE SHOWN TO ASSIST THE CONTRACTORS IN BIDDING WORK. HOWEVER, MINOR VARIATIONS IN THE BUILDING TYPES ARE TO BE EXPECTED, THE CONTRACTOR IS TO INSPECT AND VERIFY ALL QUANTITIES IN THE FIELD PRIOR TO BIDDING.
- REFER TO MASONRY RESTORATION NOTES ON THIS SHEET.
- 8. REFER TO SHEET A8.01 FOR WINDOW TYPES AND DETAILS.

DRAWING NOTES

REFER TO SHEET ALOI FOR GENERAL DEMOLITION NOTES, NUMBERED DEMOLITION NOTES, GENERAL CONSTRUCTION NOTES AND NUMBERED CONSTRUCTION NOTES.

MASONRY RESTORATION MATRIX	
BUILDING NUMBER	AREA TO REPOINT
BUILDING A	20 SF
BUILDING B	2 SF
BUILDING C	66 SF
COMM. BUILDING	15 SF
TOTAL SF	103 SF

MASONRY RESTORATION LEGEND	
SHADED AREA	DESCRIPTION
	AREA INDICATED ON ELEVATIONS FOR MASONRY REPOINTING



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BUILDING **ELEVATIONS**


2 REAR ELEVATION

A2.02 SCALE: 1/8' = 1'-0'

BOOT TO REMAIN, (TYP.)


REMOVE & REPLACE EX BRICK— SOLDIER COLIRSE & PRE-CAST CONC LINTEL (MATCH EXISTING)

WHERE INDICATED

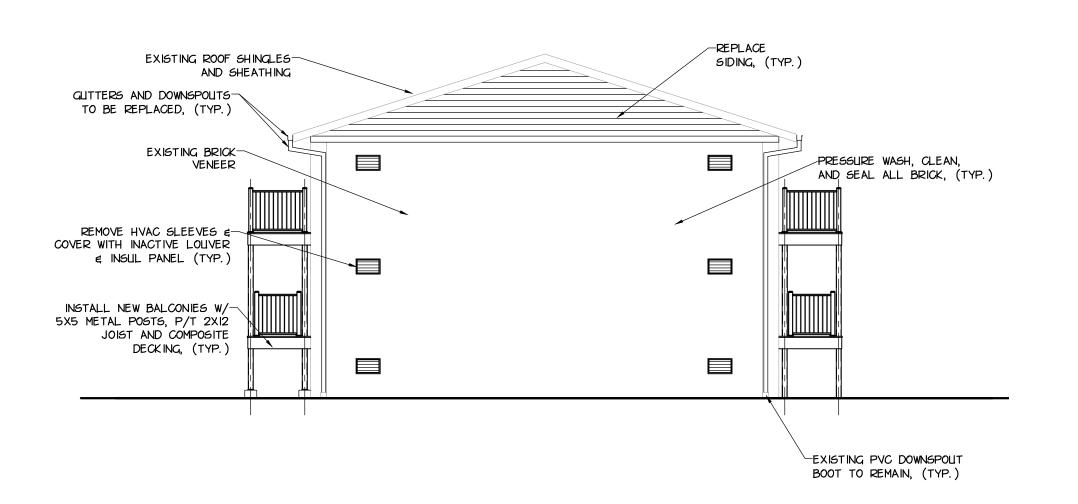

COMPOSITE PANEL, (TYP.)



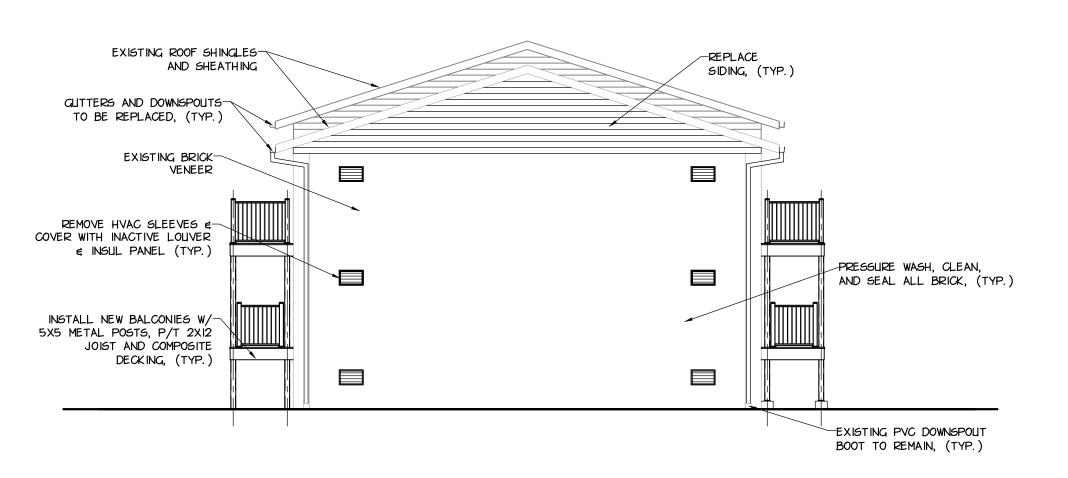

BUILDING AND APARTMENT

NUMBERS ON BACKBOARD

4 LEFT SIDE ELEVATION

A2.02 SCALE: 1/8' = 1'-0'

PRESSURE WASH, CLEAN,

AND SEAL ALL BRICK, (TYP.)


DRAWING NOTES

REFER TO SHEET ALOI FOR GENERAL DEMOLITION NOTES, NUMBERED DEMOLITION NOTES, GENERAL CONSTRUCTION NOTES AND NUMBERED CONSTRUCTION NOTES. REFER TO SHEET A2.01 FOR MASONRY RESTORATION NOTES.



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BUILDING B ELEVATIONS

SHEET NUMBER

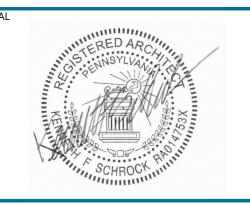A2.02






REFER TO SHEET ALOI FOR GENERAL DEMOLITION NOTES, NUMBERED DEMOLITION NOTES, GENERAL CONSTRUCTION NOTES AND NUMBERED CONSTRUCTION NOTES.
REFER TO SHEET A2.01 FOR MASONRY RESTORATION NOTES.

SLEIGHTER DESIGN

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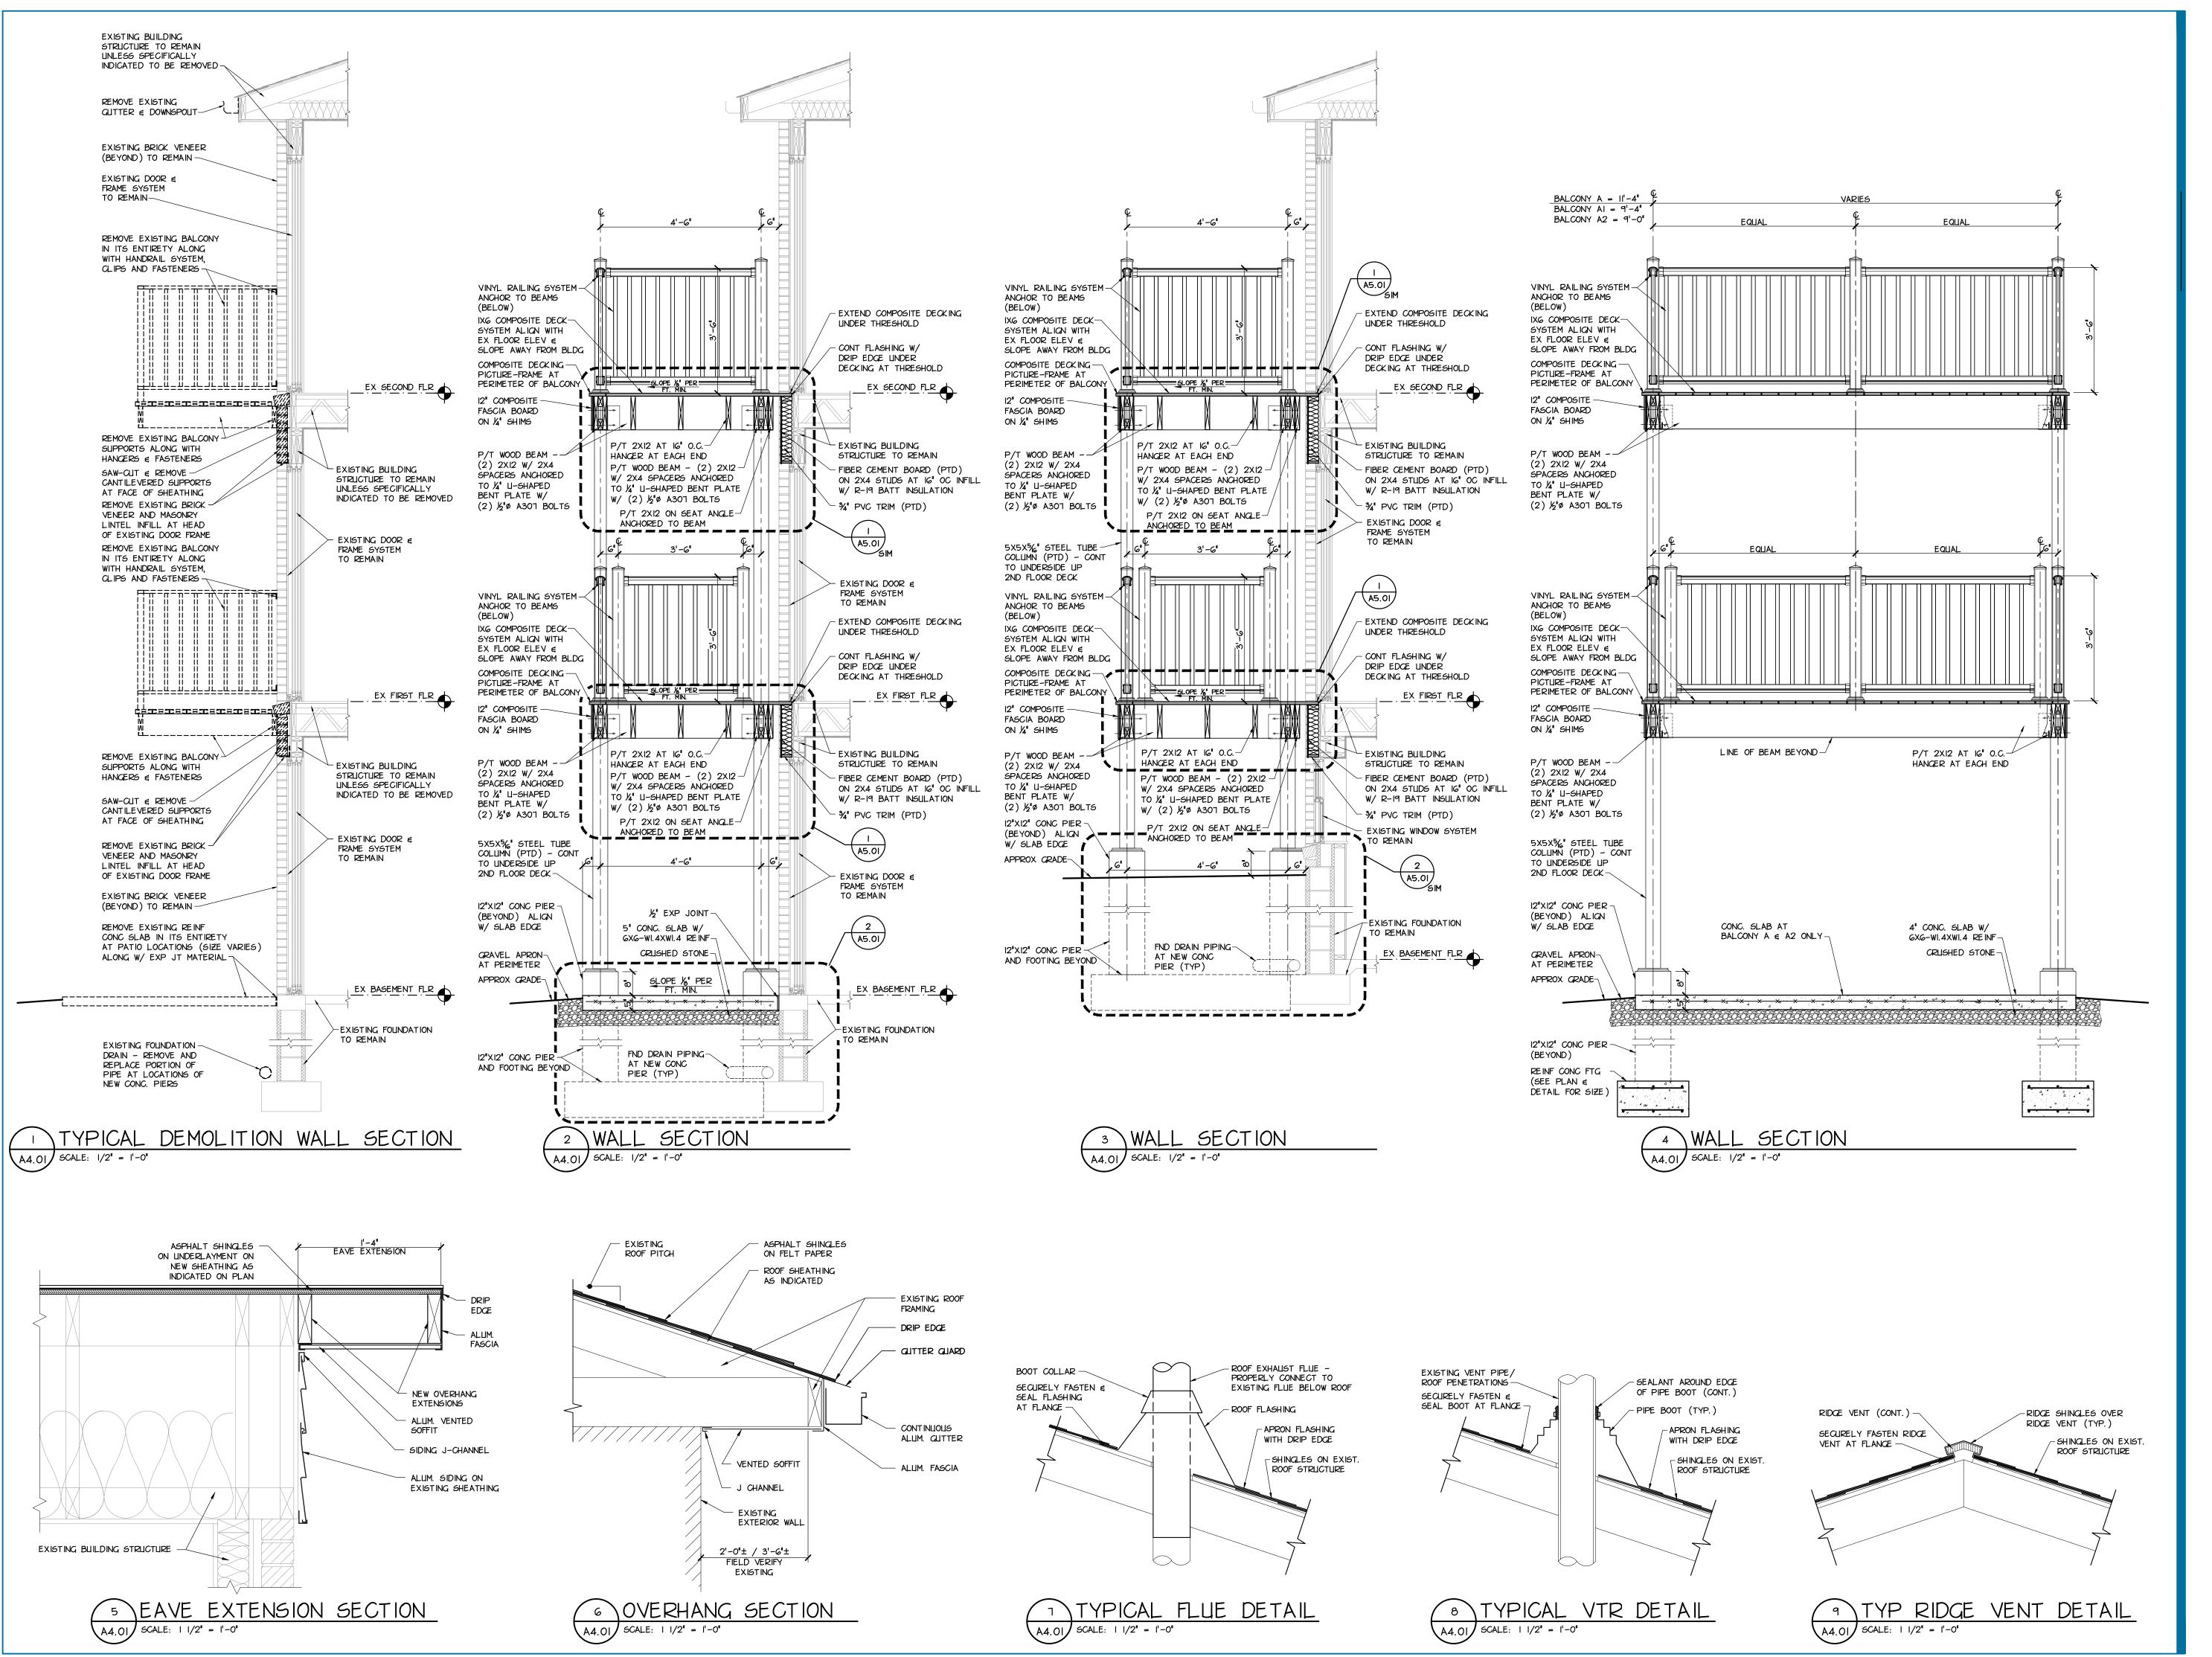
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BUILDING C ELEVATIONS

SHEET NUMBER

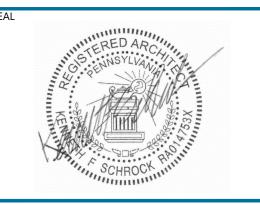A2.03





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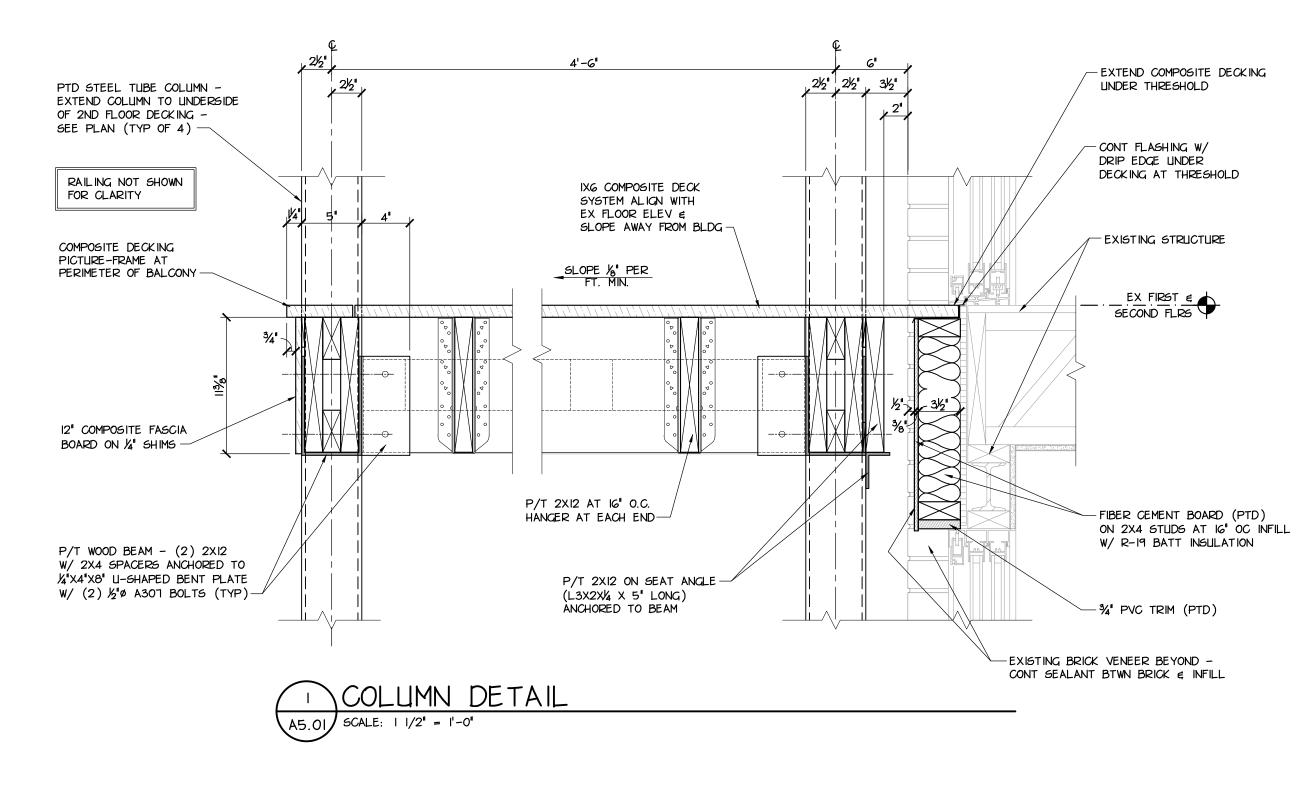
WALL


SECTIONS

SHEET NUMBER

SHEET NAME


A4.01




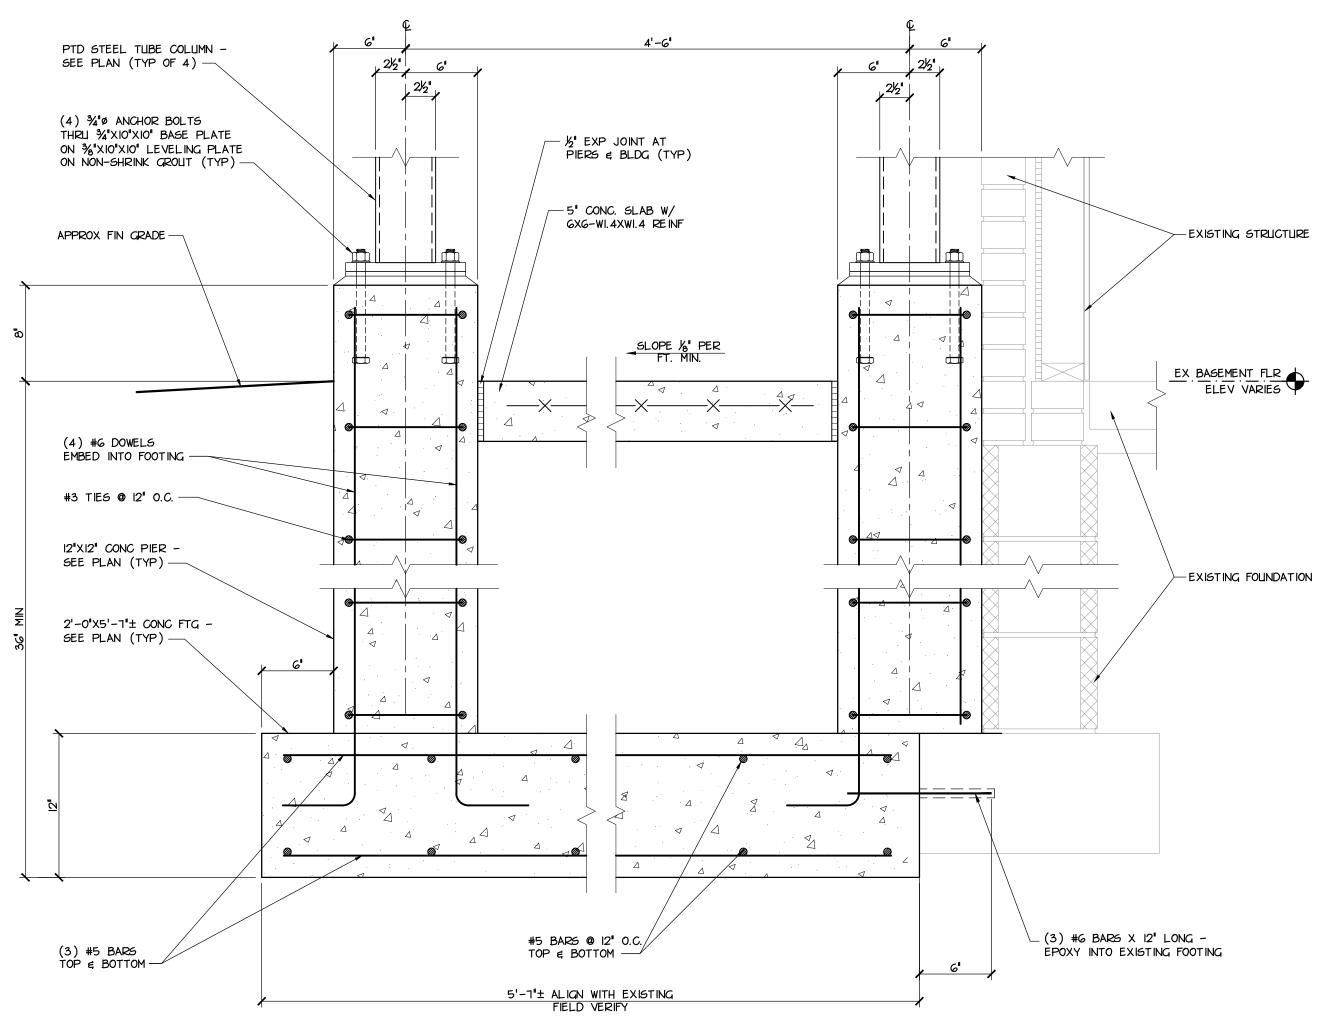

PIER & FOOTING DETAIL

A5.01 SCALE: 1 1/2" = 1'-0"

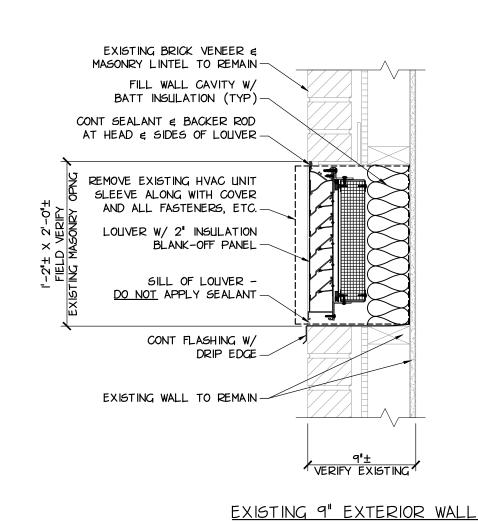

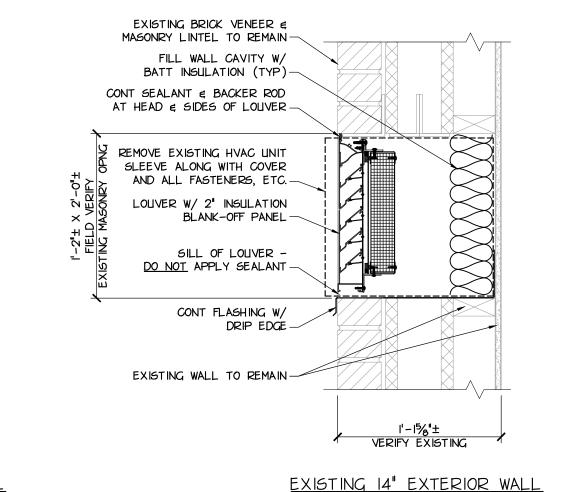

3 LOUVER DETAILS
A5.01 SCALE: 1 1/2" = 1'-0"



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PROJECT NUMBER R24-077-01


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DETAILS


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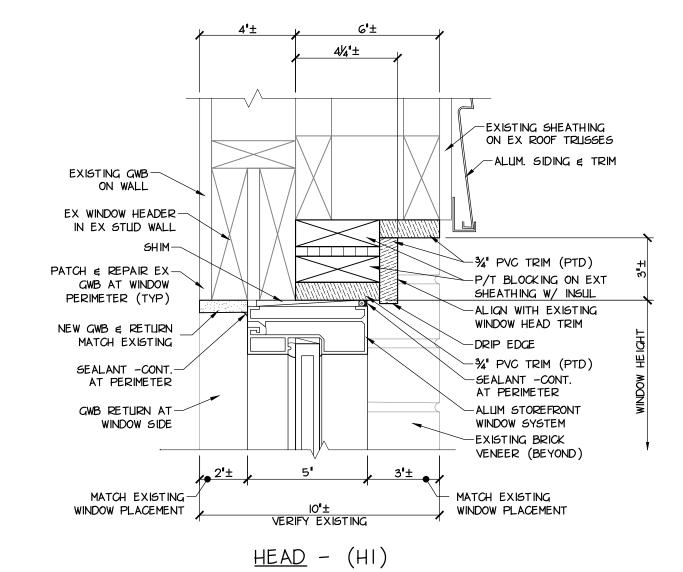
A5.01





WINDOW TYPES


AB.OI) SCALE: 1/4" = 1'-0"

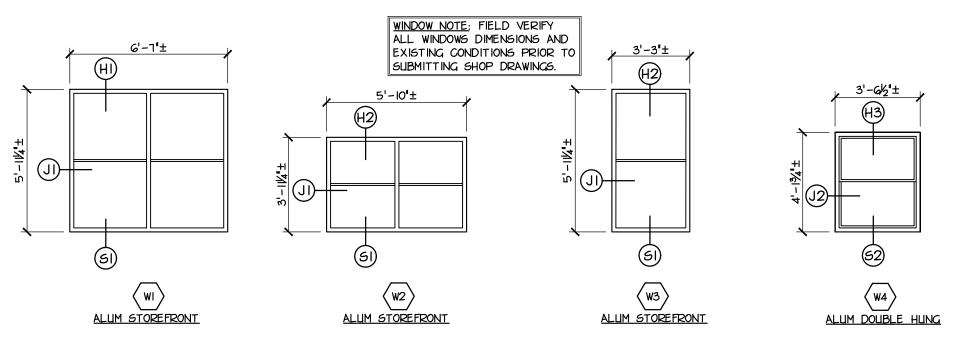


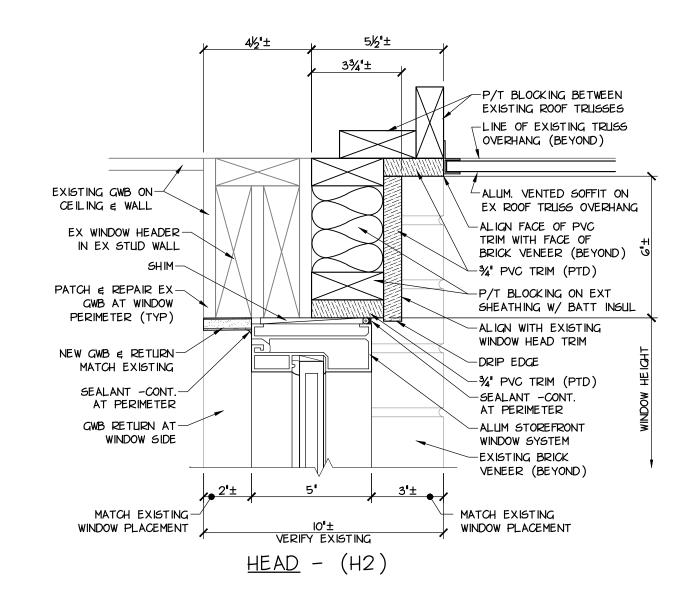


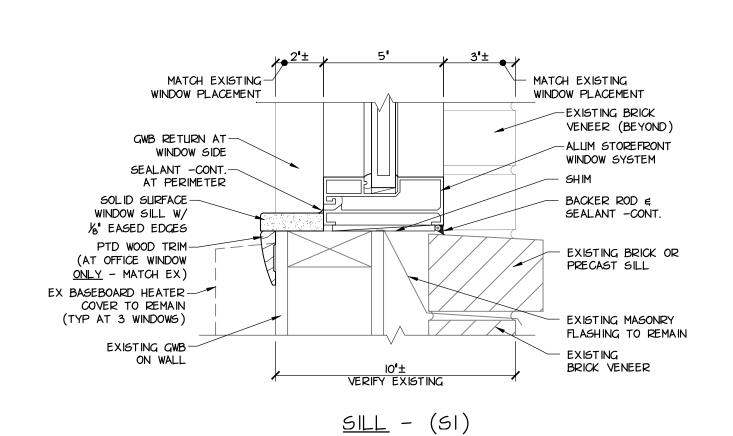

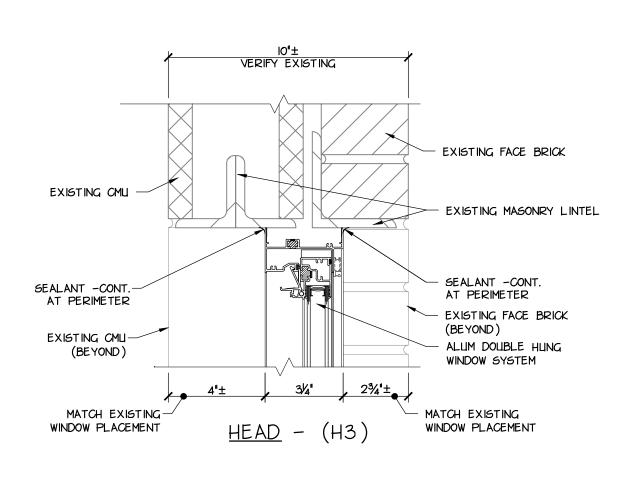

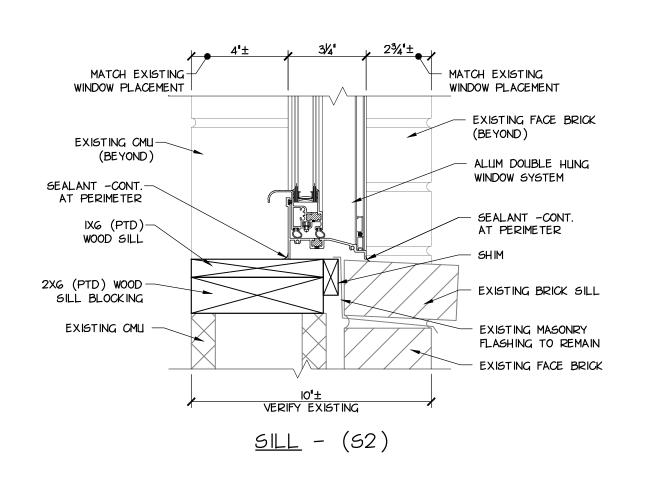

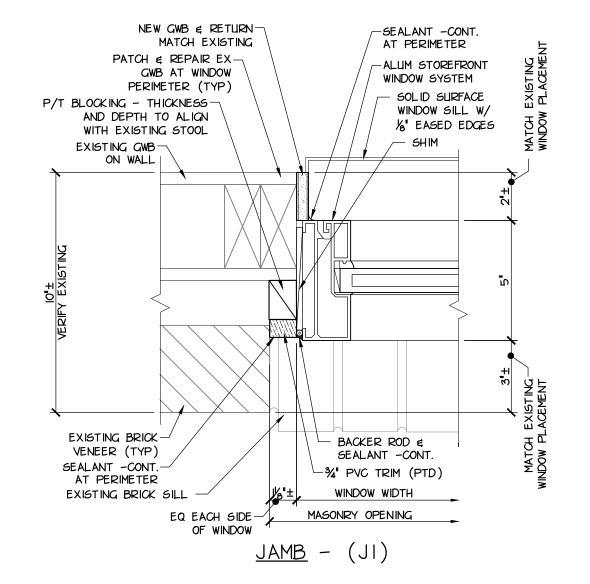

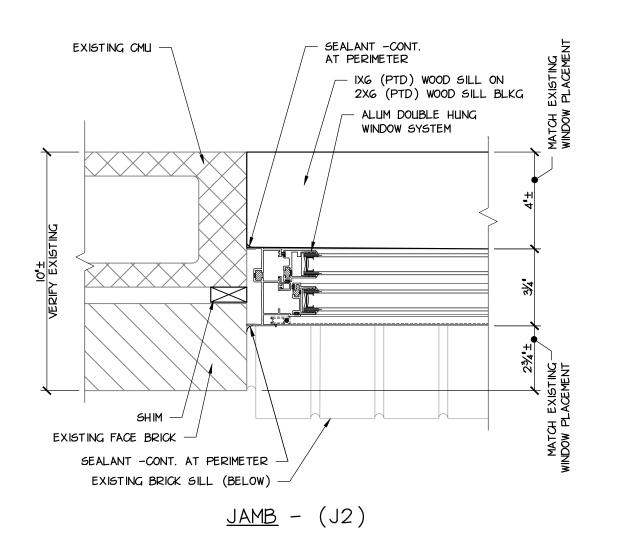



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WESTMORELAND COUNTY

HOUSING AUTHORITY

R24-077-01

PROJECT NUMBER

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WINDOW TYPES AND DETAILS

CHEET NILIMBEI

A8.01

P:\077 - Westmoreland County Housing Authority\R24-077-01 - WCHA - New Stanton Manor - Exterior Renovations\Dwg\Sheets\A8.01.dwg, Date:

WINDOW DETAILS

SCALE: 3' = 1'-0'